



**EXTERIOR ELEVATION NOTES**

**BUILDERS SPECIFICATION MAY GOVERN OVER THESE NOTES**

**EXTERIOR WALL FINISH**

- SIDING / STUCCO C/W REQ'D TRIMS AND FLASHINGS
- STONE VENEER AS SHOWN C/W TOP LEDGE

**ROOFING FINISH**

- ASPHALT SHINGLES

**FASCIA & SOFFITS**

- PREFINISHED PERFORATED SOFFIT
- PREFINISHED METAL FASCIA ON 2x10 FRAMING

**EAVESTROUGH**

- PREFINISHED METAL EAVESTROUGH AND DOWNSPOUTS WITH EXTENTIONS, C/W ALL MOUNTING HARDWARE.

**WINDOWS**

- PVC WINDOW UNITS C/W REQ'D GRILLES AS SHOWN (REFER TO WINDOW SHOP DRAWINGS FOR EXACT TYPE, SIZE AND STYLE OF WINDOW. BUILDER/OWNER TO VERIFY DIRECTION OF ALL OPENERS.

**PARGING**


- CEMENT PARGING ON FOUNDATION WALL, MAX. 2'-0" HIGH

**REAR DECK**


- DECKING ON PRESSURE TREATED STRUCTURE
- ALUMINUM RAILING SYSTEM AS INDICATED (RAILING TO MEET OR EXCEED REQUIREMENTS OF ABC)

**FRONT DECK**


- CAST IN PLACE CONCRETE
- ALUMINUM RAILING SYSTEM AS INDICATED (RAILING TO MEET OR EXCEED REQUIREMENTS OF ABC)

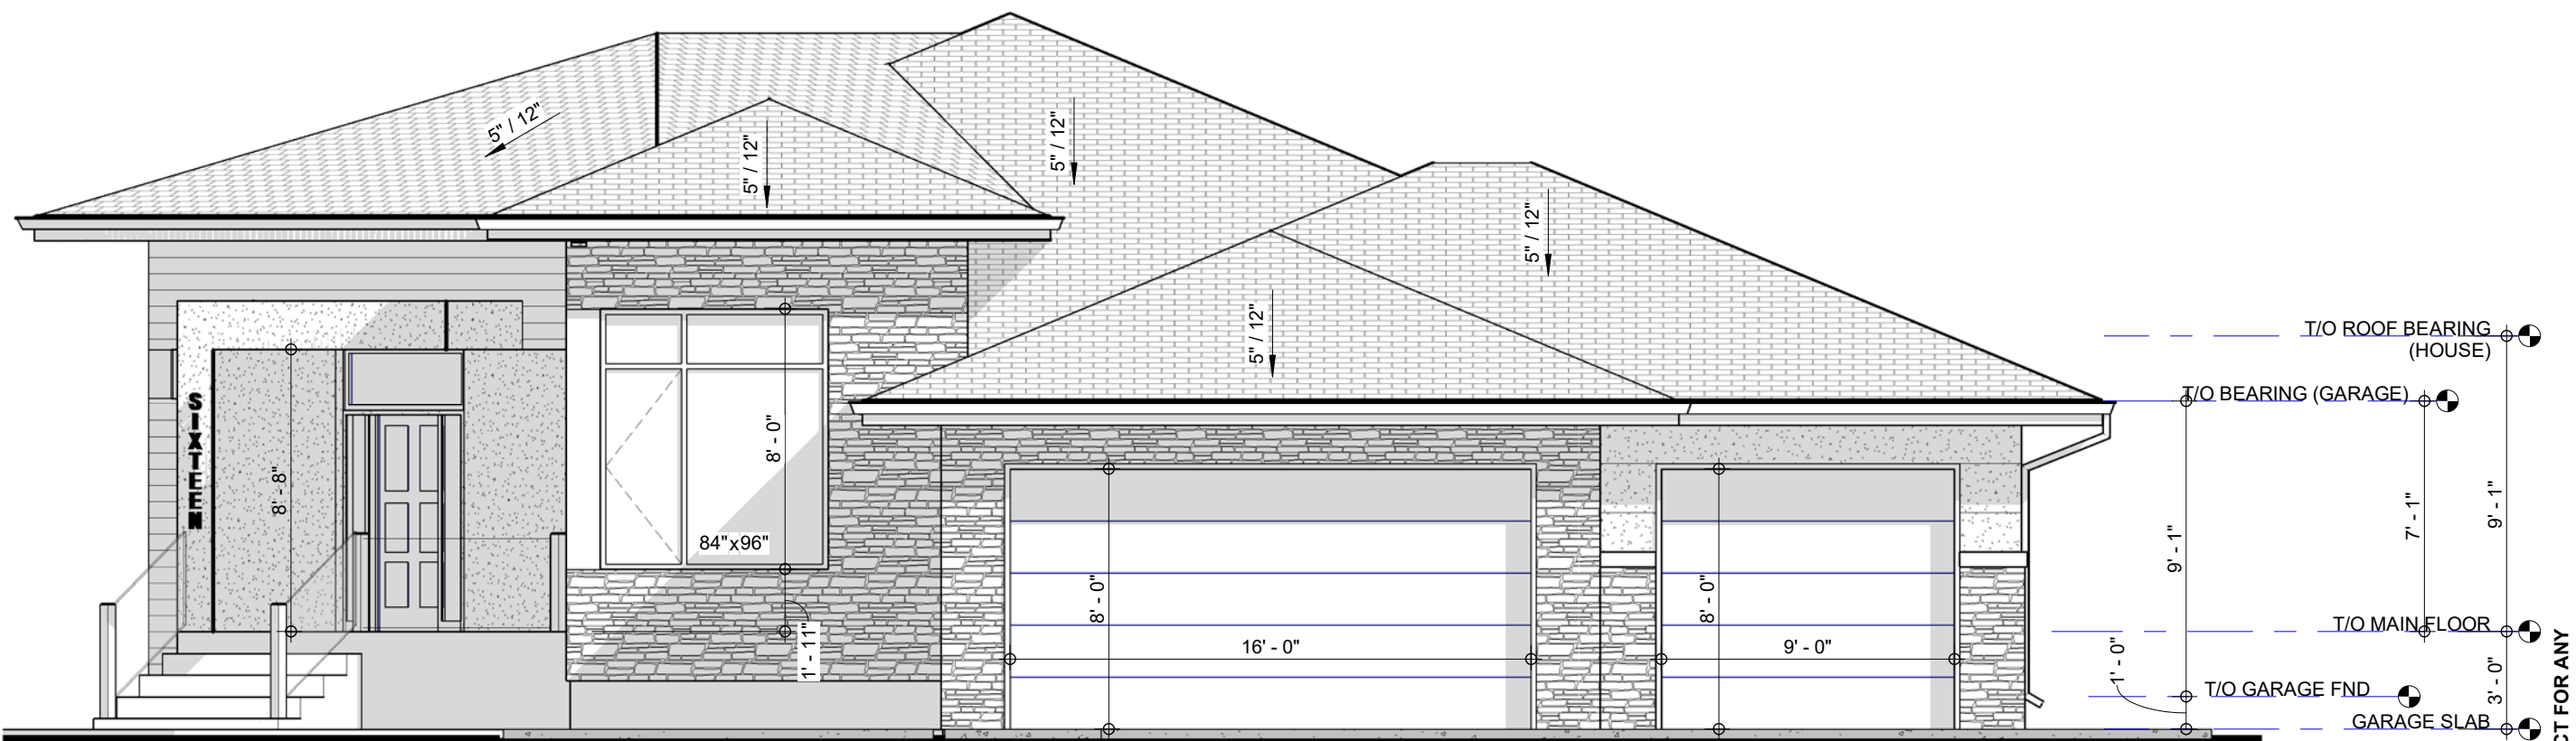


**FRONT ELEVATION**  
3/16" = 1'-0"

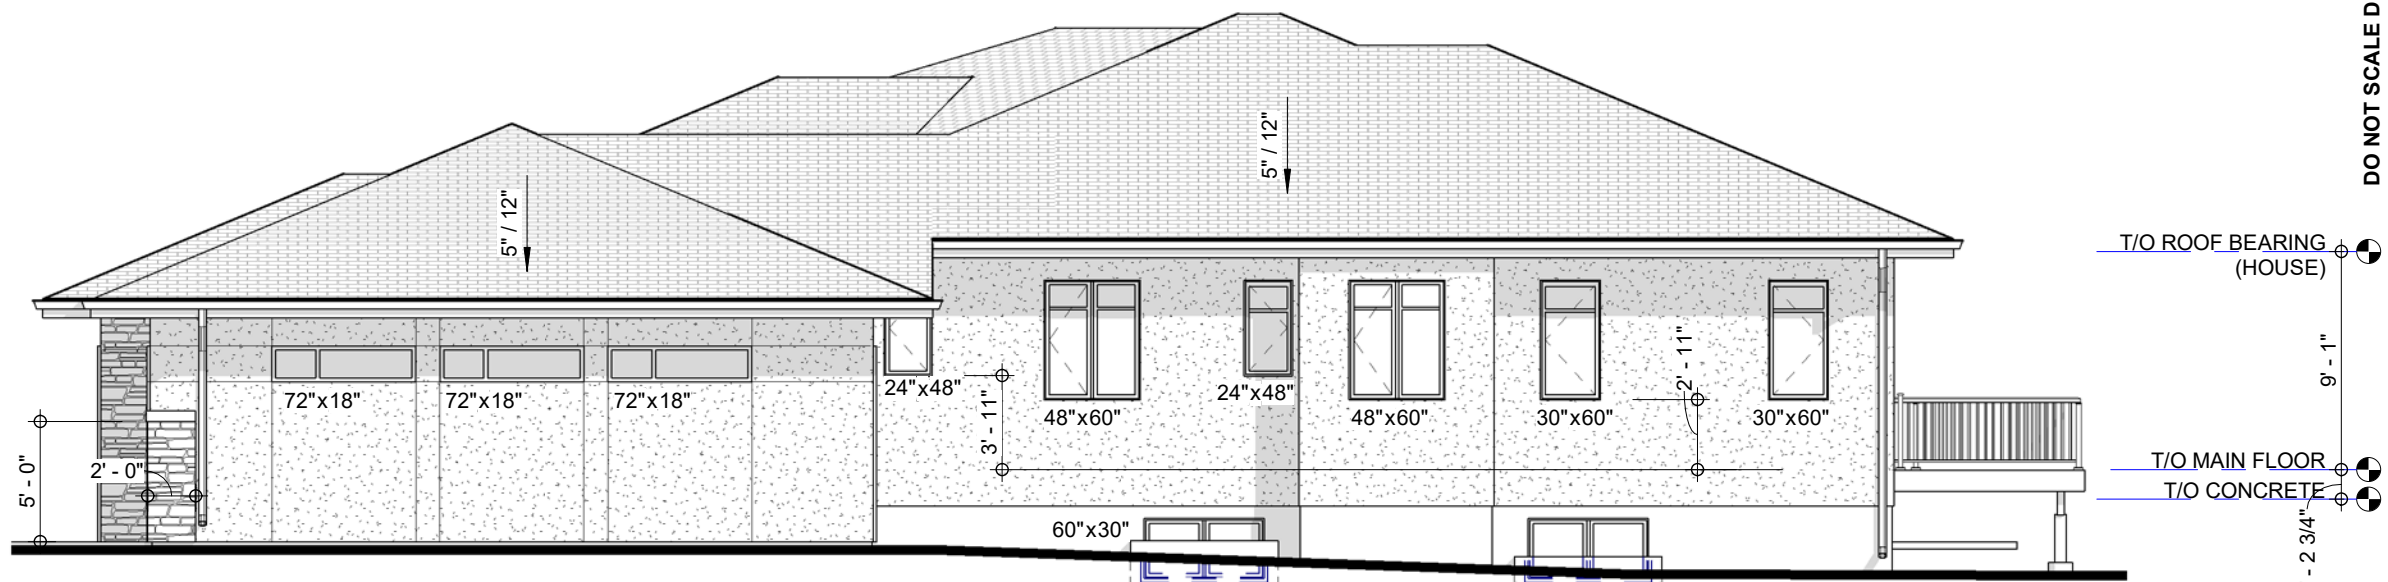

**RIGHT SIDE ELEVATION**  
1/8" = 1'-0"

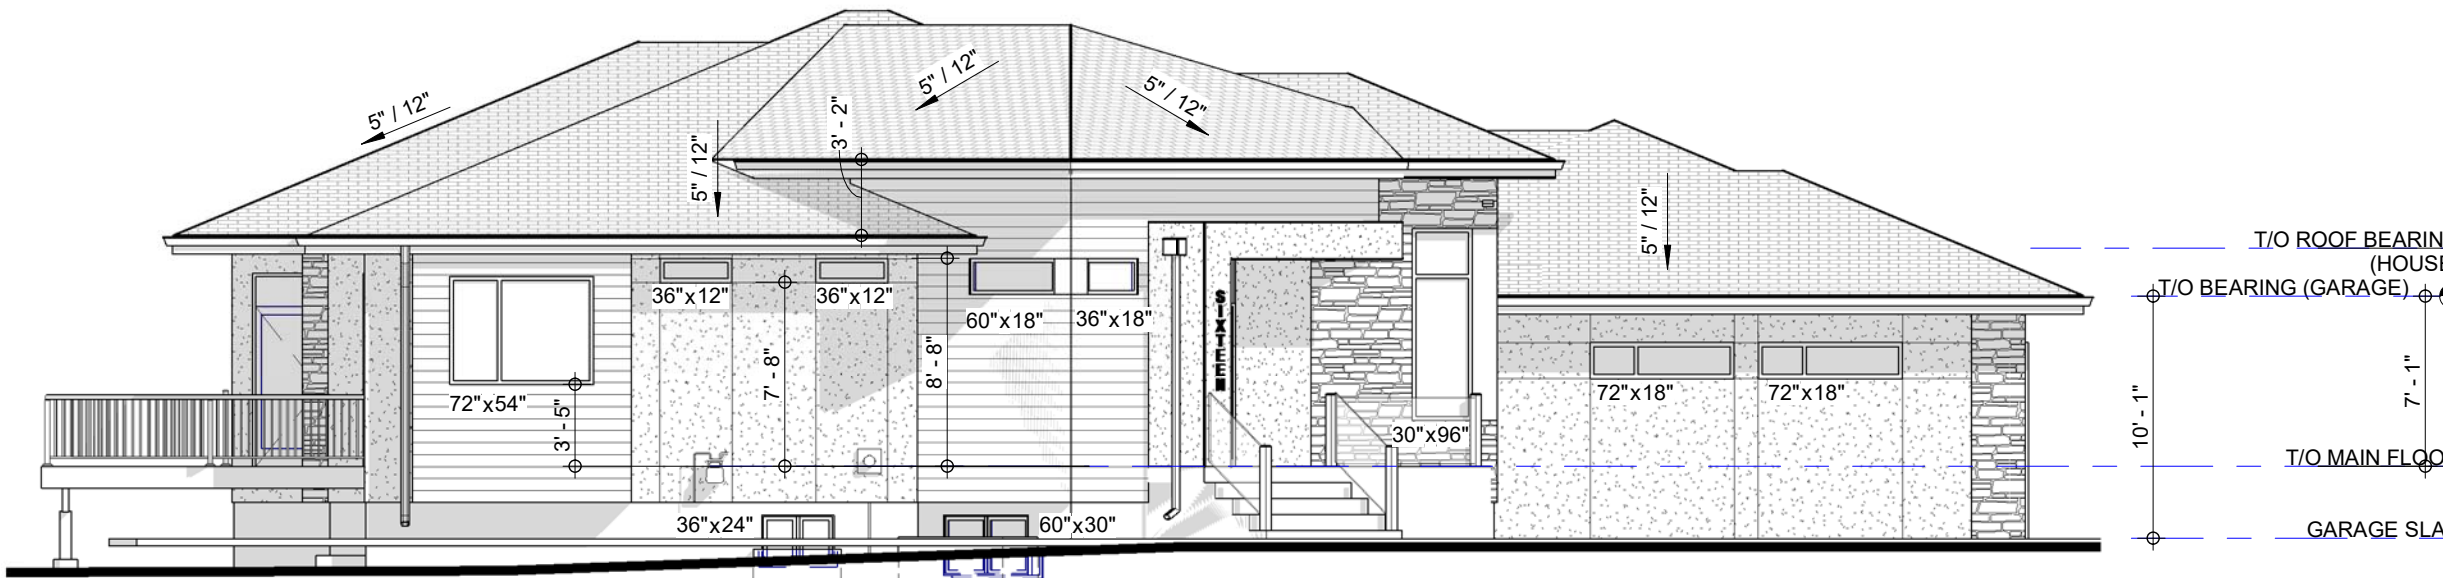

**LEFT SIDE ELEVATION**  
1/8" = 1'-0"

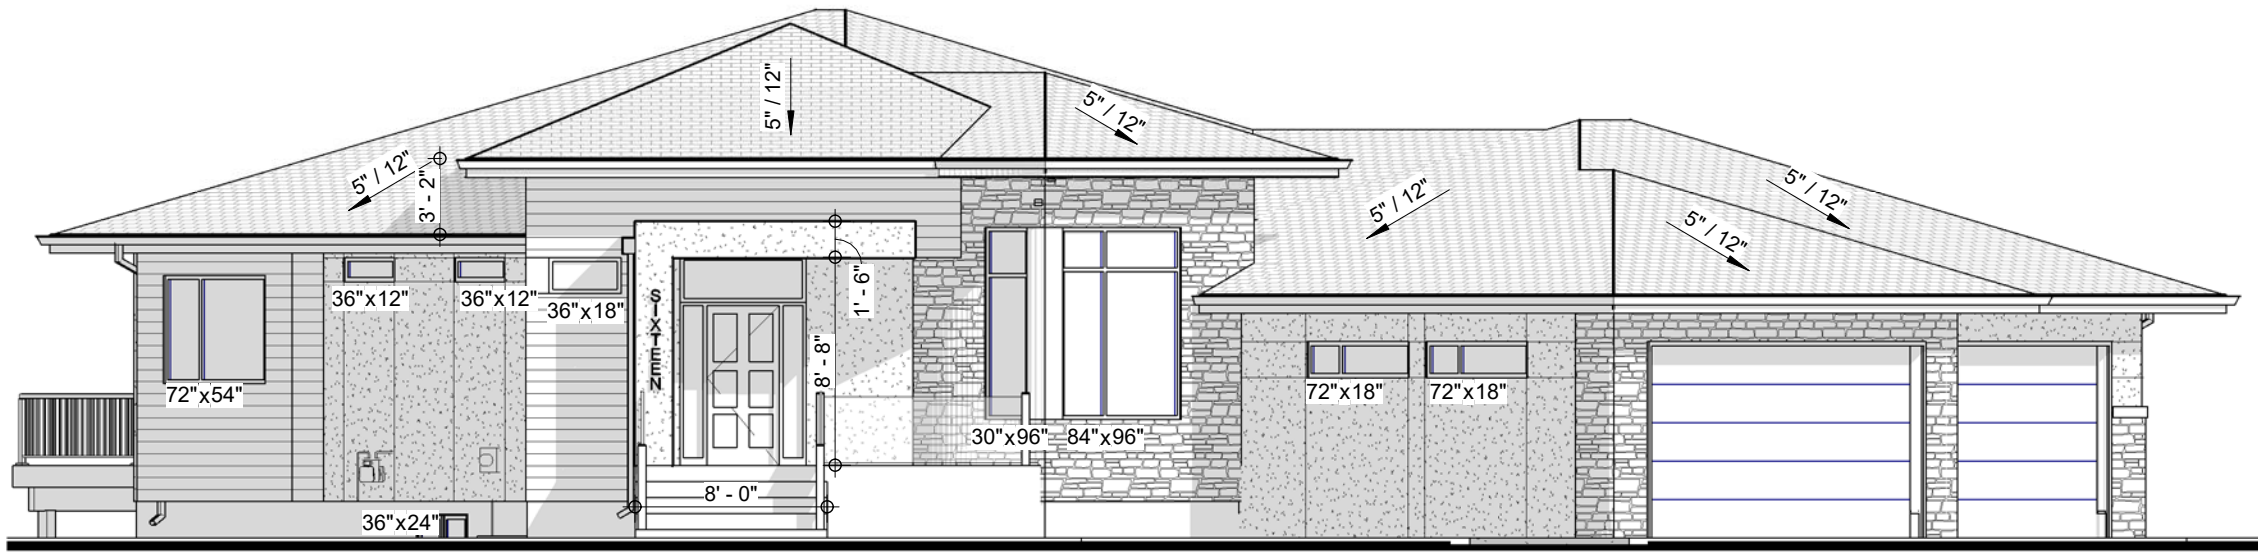

**FRONT ENTRY "HEAD ON" ELEVATION**  
1/8" = 1'-0"



**BACK ELEVATION**  
1/8" = 1'-0"



**DO NOT SCALE DRAWINGS. CONTACT FOR ANY RECD INFO OR CLARIFICATION!!!**  
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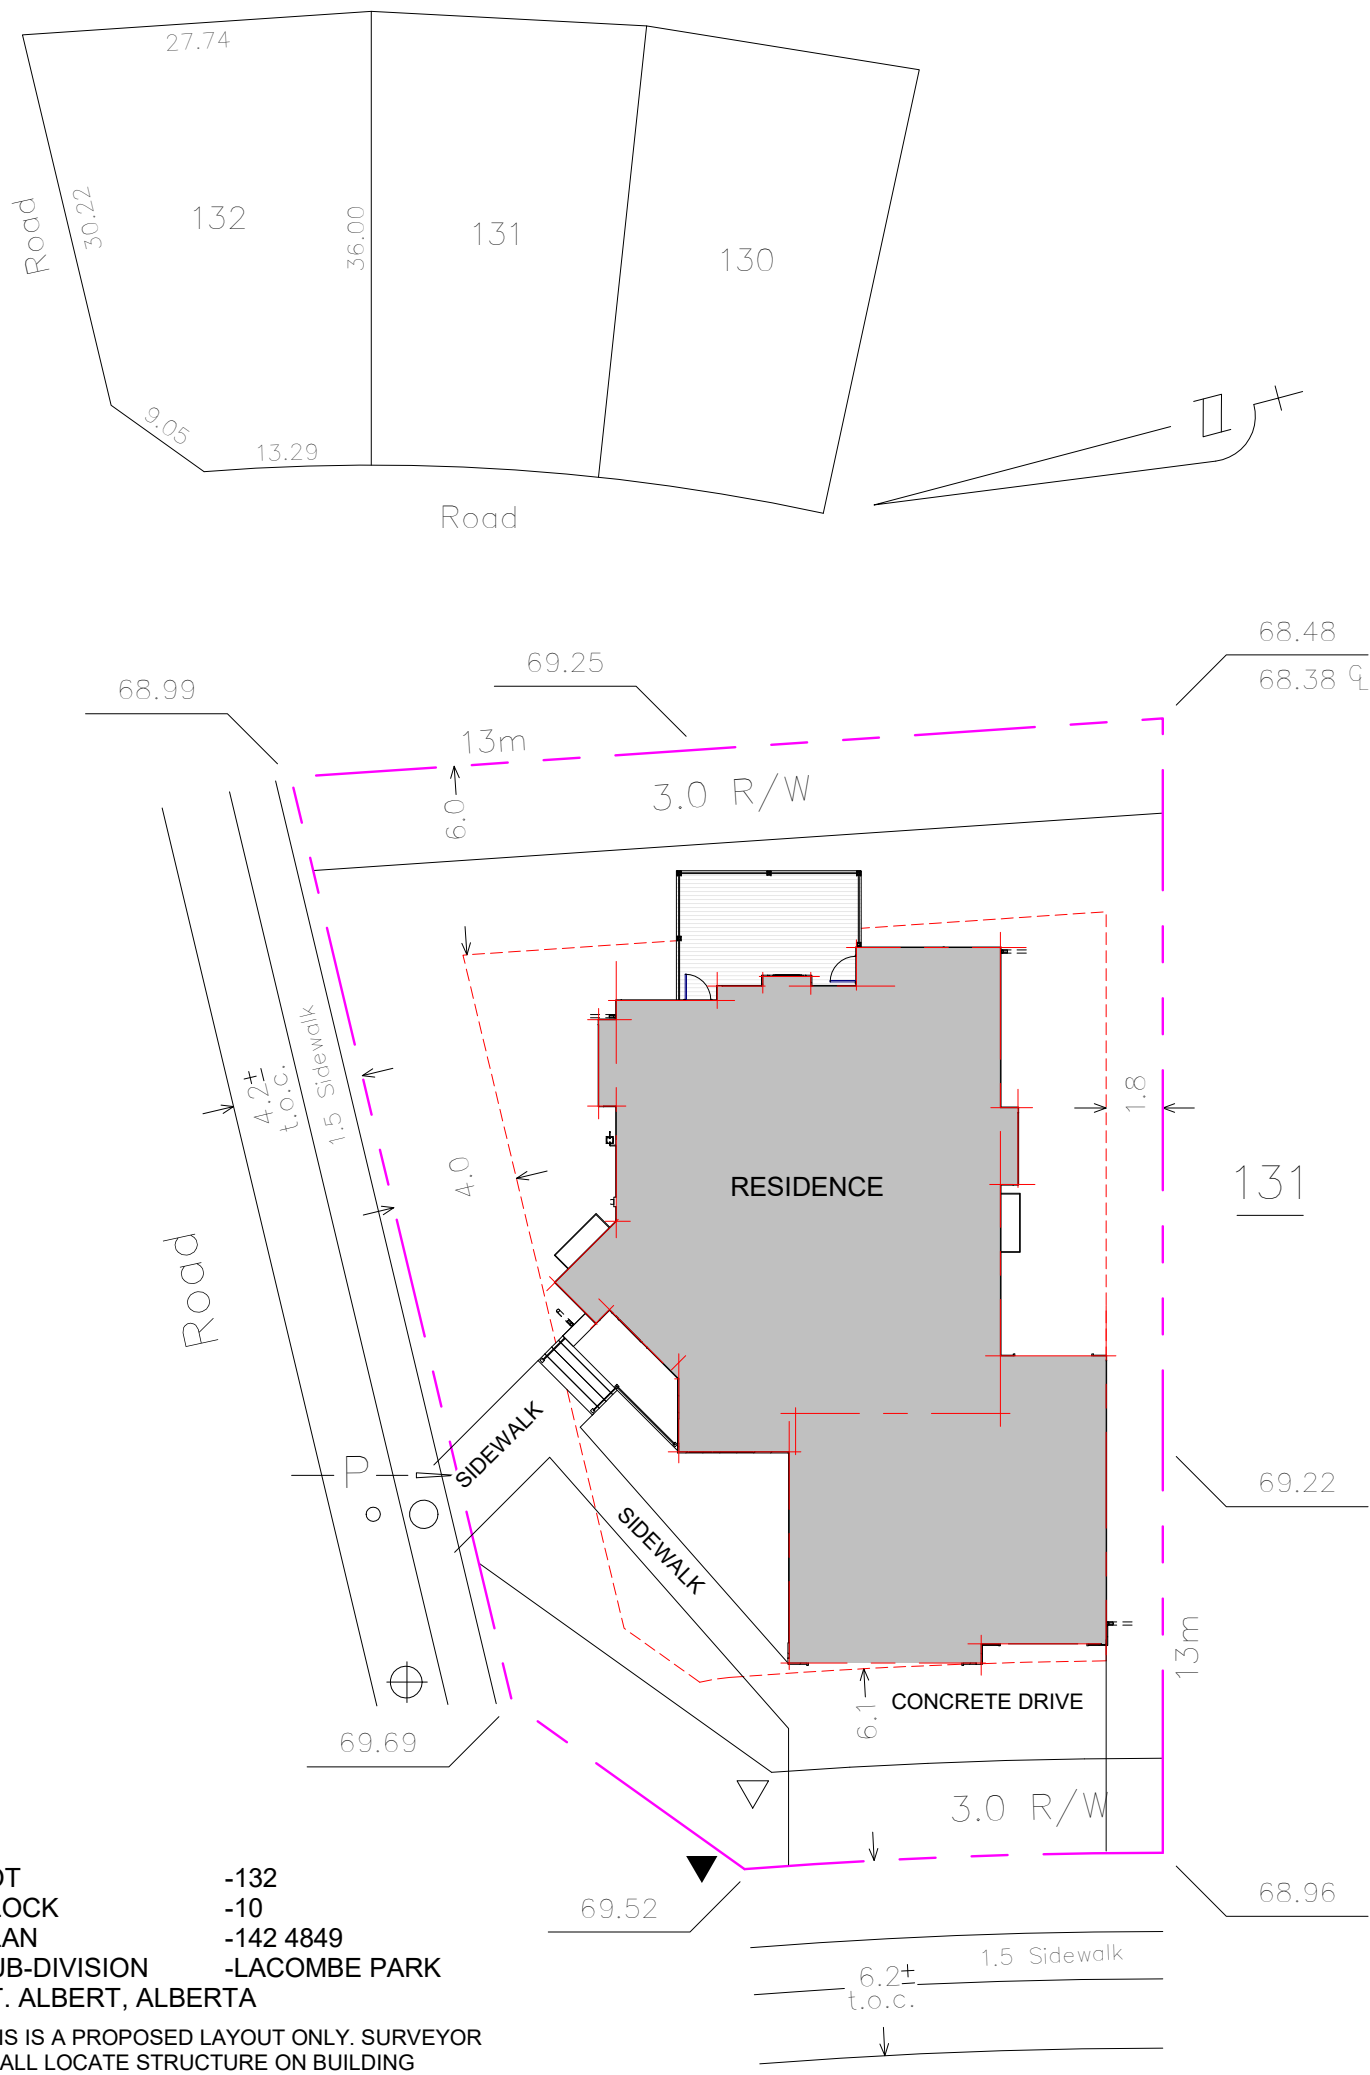
Project No:	2018-61
Date:	JULY 2019
Scale:	As indicated
Drawn By:	BMW
Builder File:	
Legal Description:	
Lot:	132
Block:	10
Plan:	142 4849
Subdivision:	LACOMBE PARK
Address:	

**EXTERIOR ELEVATIONS**

**B·M·W**  
Design & Drafting Ltd.  
#2128110 TWP RD 542A  
331 DEL.

**DAYNEL HOMES**

**A-1**



LOT -132  
 BLOCK -10  
 PLAN -142 4849  
 SUB-DIVISION -LACOMBE PARK  
 ST. ALBERT, ALBERTA

THIS IS A PROPOSED LAYOUT ONLY. SURVEYOR SHALL LOCATE STRUCTURE ON BUILDING POCKETS TO APPROPRIATE SETBACKS AND GRADES AND VERIFY WITH OWNER.

**SITE AREA** -820.5 SQ.M.  
**BUILDING AREA** -265 SQ.M.  
 (INCLUDES COVERED DECKS, DECKS OVER 1M IN HEIGHT AND ACCESSORY BUILDINGS)  
**SITE COVERAGE** 32%

**SITE PLAN** Front  
 1" = 20'-0"

**BASEMENT CONSTRUCTION NOTES**

**BUILDERS SPECIFICATION MAY GOVERN OVER THESE NOTES**

**COLUMN FOOTINGS**  
 -STEEL TELEPOST ON 42" SQ.X10" THK. REINFORCED AS PER CONTRACTOR OR ENGINEER SPECIFICATIONS  
 (TELEPOST AND CONCRETE PAD SIZES TO BE VERIFIED ONCE BEAM LOADS ARE KNOWN)

-PROVIDE CONTINUOUS FILTER FABRIC SOCK AROUND 4" WEEPING TILE TO BE INSTALLED AROUND ENTIRE PERIMETER OF STRIP FOOTING WITH MIN. 12" GRAVEL COVER AND TIED TO DRAINAGE SYSTEM ACCORDING TO LOCAL BYLAWS (TYP.)

-PROVIDE GALVANIZED WINDOW WELLS TO SUIT GRADE. FILL WELLS WITH FILTER FABRIC UNDER 6" OF GRAVEL. PROVIDE PVC PIPE CONNECTION TO WEEPING TILE. MODIFY MAIN FLOOR ELEVATION AS REQ'D. VERIFY CONDITION ON SITE.

-PROVIDE JOIST BLOCKING AS PER JOIST MANUF. (TYP.)

-VERIFY BEAM AND JOIST SIZES WITH MANUF. (TYP.)


-PROVIDE DECK NAILER AS PER ELEVATIONS

-PROVIDE BEAM POCKETS AS NEEDED FOR BEAM LAYOUT. VERIFY LOCATION AND SIZES WITH JOIST LAYOUT DRAWINGS.

-JOIST AND BEAM LAYOUT TO BE CONFIRMED BY SUPPLIER OF JOISTS AND BEAMS.

-INSULATE, SEAL AND PROVIDE PREFINISHED METAL SOFFIT TO ALL CANTILEVERS

-SUMP PIT, FURNACE, HOT WATER TANK, ELECTRICAL PANEL LOCATIONS TO BE CONFIRMED ON SITE

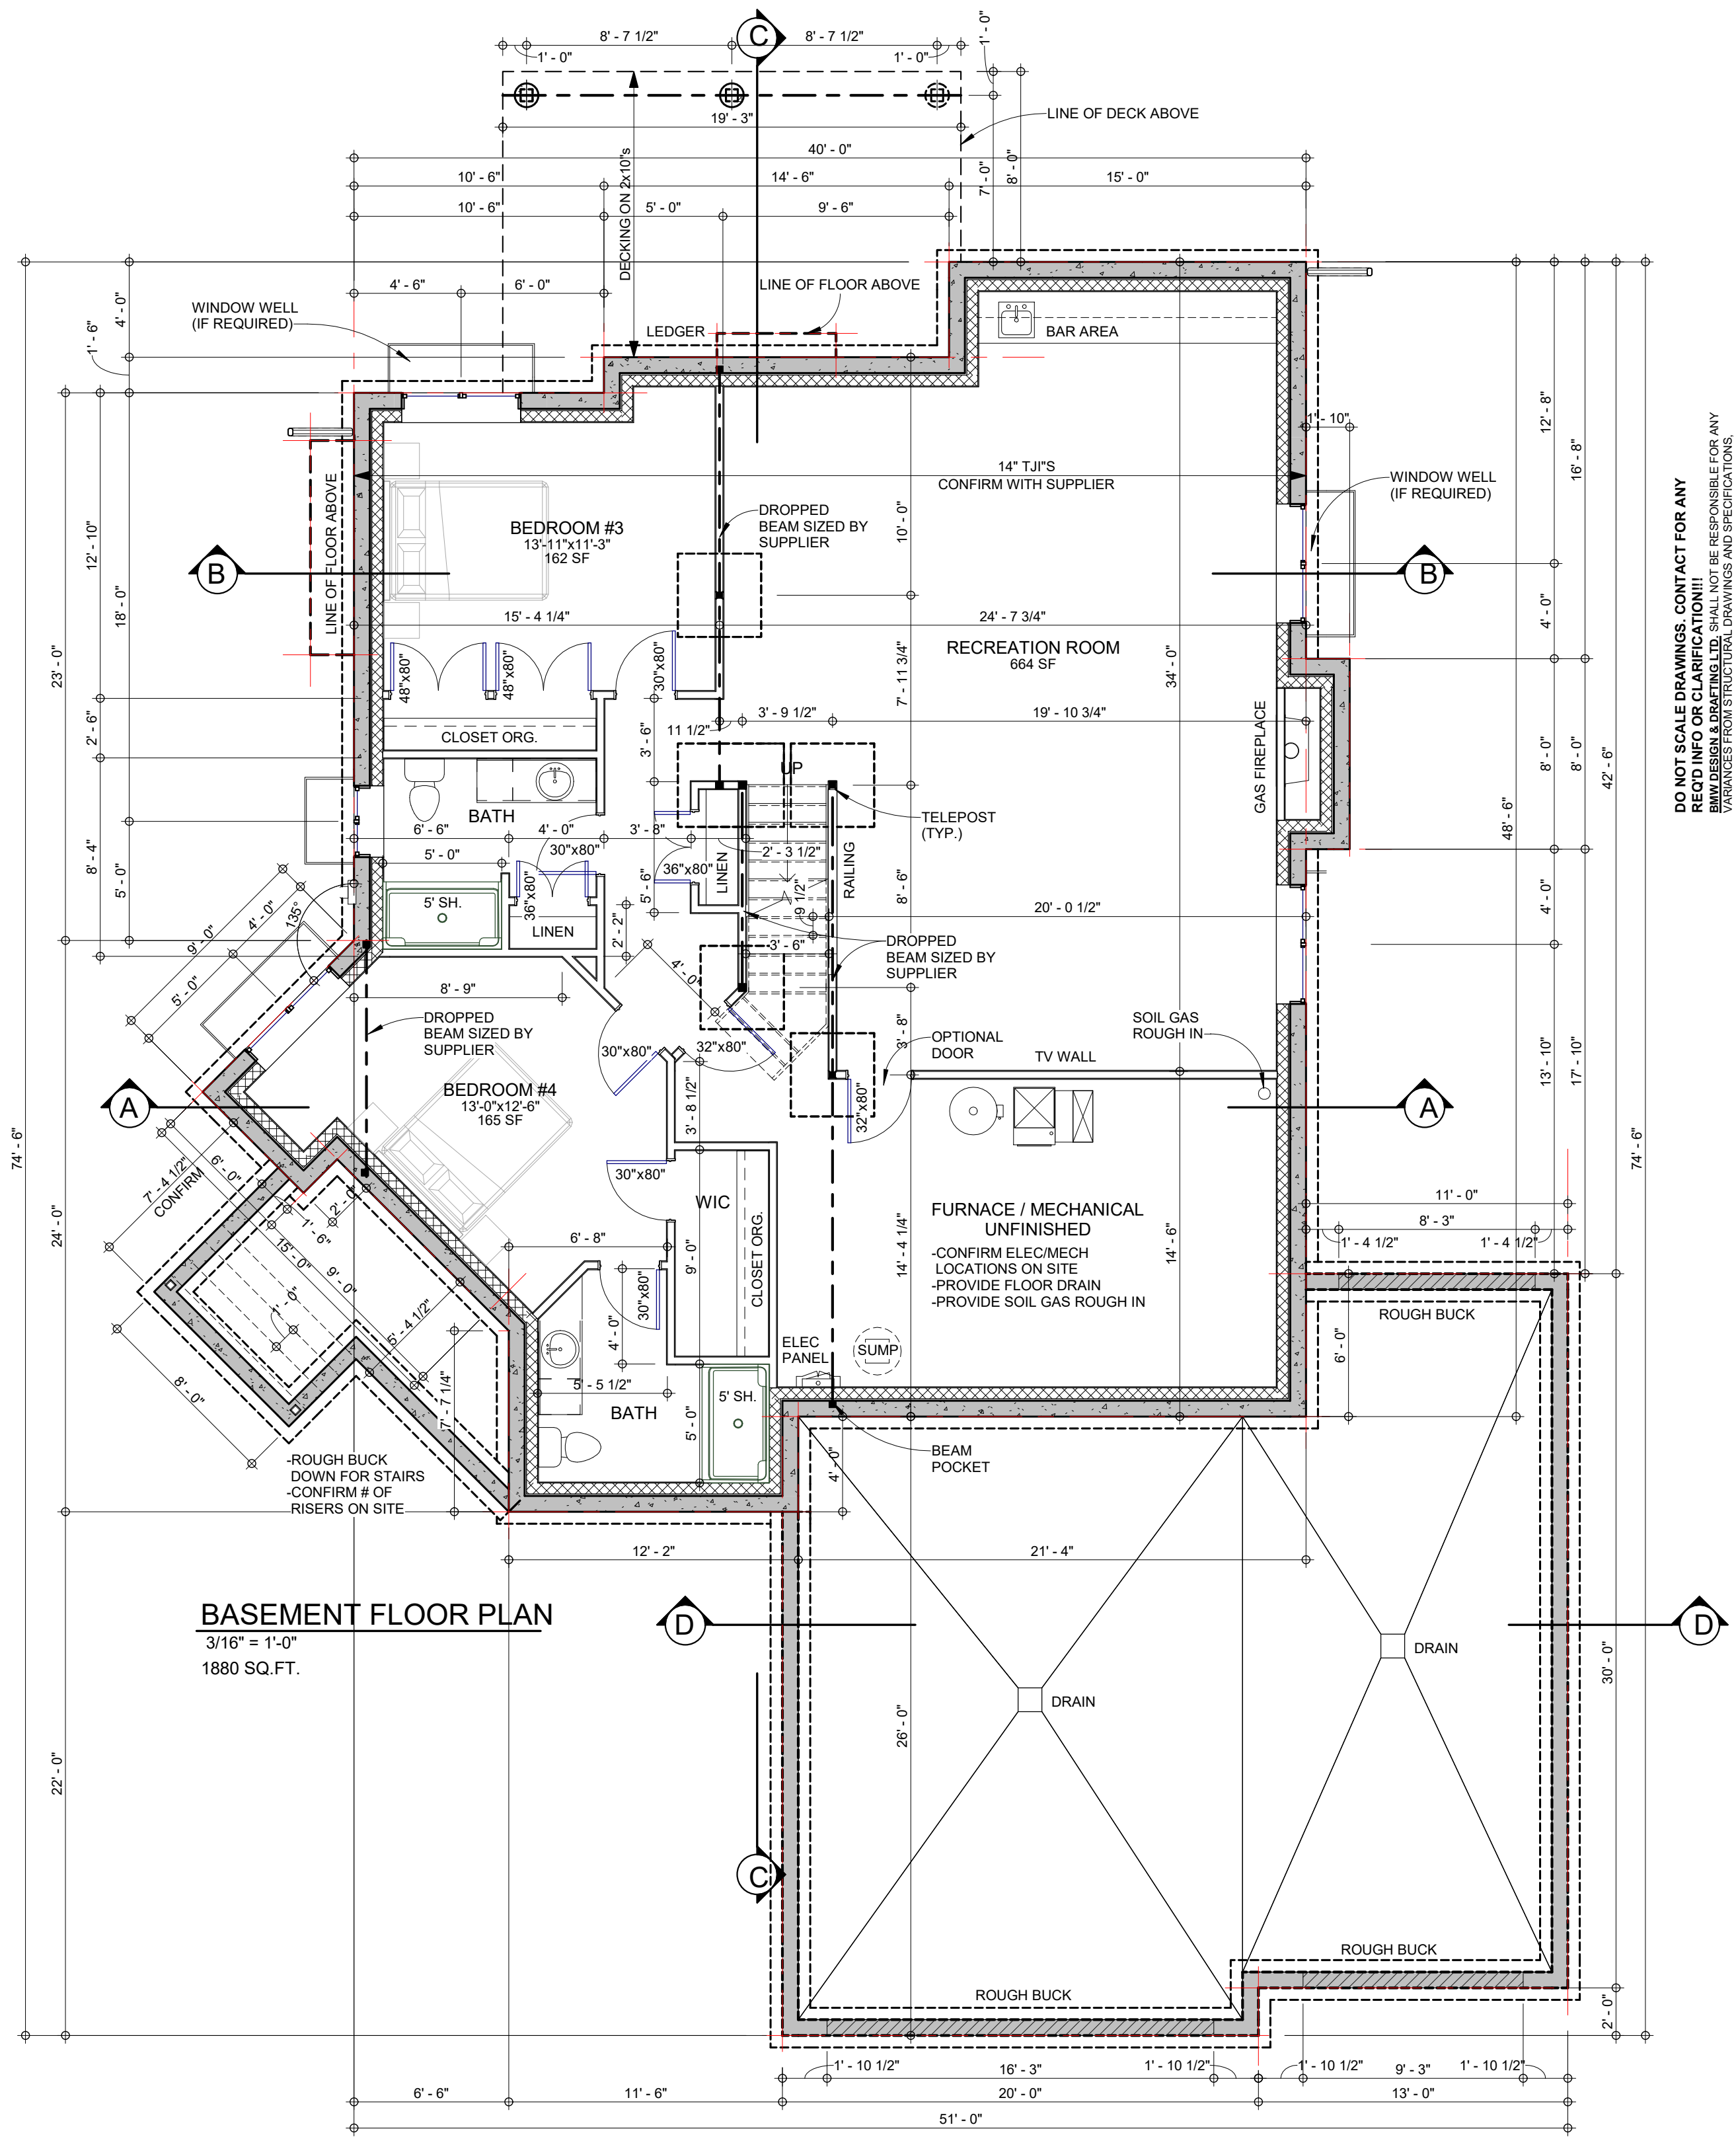

**BASEMENT FLOOR PLAN**  
 3/16" = 1'-0"  
 1880 SQ.FT.

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**BMW DESIGN & DRAFTING LTD.** MAKES EVERY EFFORT TO PROVIDE COMPLETE AND ACCURATE CONSTRUCTION DRAWINGS. HOWEVER, WE ASSUME NO LIABILITY FOR ANY ERRORS OR OMISSIONS WHICH MAY AFFECT CONSTRUCTION. IT IS THE RESPONSIBILITY OF ALL TRADES AND SUB TRADES TO CHECK AND VERIFY ALL DIMENSIONS AND CONDITIONS ON THE JOB SITE. ANY DISCREPANCIES FOUND ON THESE PLANS PLEASE ADVISE OUR OFFICE SO WE CAN MAKE THE NECESSARY CORRECTIONS.

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Drawing Title:	BASEMENT FLOOR PLAN
Builder:	DAYNEL HOMES
Design & Drafting Ltd.	
#21-28112 TWP RD 542A	
331 DEL.	

**CONSTRUCTION ASSEMBLIES**

**BUILDERS SPECIFICATION MAY GOVERN OVER THESE NOTES**

**WALL TYPES**

**HOUSE FOUNDATION WALL CONSTRUCTION (FW1)**  
 -DAMP PROOFING ON 8" CONC. FDN WALL ON STRIP FOOTING (REINFORCED AS PER CONTRACTOR OR ENGINEER SPECIFICATIONS, FOOTING REQUIREMENTS TO BE VERIFIED BY SOILS REPORT)  
 -1" AIR SPACE  
 -2x6 WOOD STUDS @ 16" O.C.  
 -R-20 BATT INSULATION  
 -6 MIL POLY VAPOUR BARRIER  
 -1/2" G.W.B.

**GARAGE FOUNDATION WALL CONSTRUCTION**  
 -8" CONC. FDN WALL (5'-0" HIGH) ON STRIP FOOTING (REINFORCED AS PER CONTRACTOR OR ENGINEER SPECIFICATIONS, FOOTING REQUIREMENTS TO BE VERIFIED BY SOILS REPORT)

**EXTERIOR WALL CONSTRUCTION (EW1) SIDING**  
 -EXTERIOR WALL FINISH AS SPEC'D  
 -AIR/MOISTURE BARRIER  
 -3/8" EXTERIOR SHEATHING (WITH REQUIRED FLAME SPREAD RATING WHERE APPLICABLE)  
 -2x6 WOOD STUDS @ 16" O.C.  
 -R-22 BATT INSULATION  
 -6 MIL POLY VAPOUR BARRIER  
 -1/2" G.W.B.

**EXTERIOR WALL CONSTRUCTION (EW2) STUCCO**  
 -EXTERIOR WALL FINISH AS SPEC'D  
 -AIR/MOISTURE BARRIER  
 -3/8" EXTERIOR SHEATHING (WITH REQUIRED FLAME SPREAD RATING WHERE APPLICABLE)  
 -2x6 WOOD STUDS @ 16" O.C.  
 -R-20 BATT INSULATION  
 -6 MIL POLY VAPOUR BARRIER  
 -1/2" G.W.B.

**GARAGE/HOUSE WALL CONSTRUCTION (EW3)**  
 -1/2" G.W.B. (GARAGE SIDE)  
 -3/8" EXTERIOR SHEATHING  
 -2x6 WOOD STUDS @ 16" O.C.  
 -R-22 BATT INSULATION  
 -6 MIL POLY VAPOUR BARRIER  
 -1/2" G.W.B.

**2x4 INTERIOR WALL CONSTRUCTION**  
 -1/2" G.W.B.  
 -2x4 WOOD STUDS @ 16" O.C.  
 -INSULATE AS INSTRUCTED BY OWNER  
 -1/2" G.W.B.

**2x6 INTERIOR WALL CONSTRUCTION**  
 -1/2" G.W.B.  
 -2x6 WOOD STUDS @ 16" O.C.  
 -INSULATE AS INSTRUCTED BY OWNER  
 -1/2" G.W.B.

**FLOOR TYPES**


**BASEMENT FLOOR CONSTRUCTION**  
 -FINISH FLOORING AS SPEC'D  
 -3-1/2" THK. CONC. FLOOR SLAB REINFORCED AS REQUIRED  
 -AIR/SOIL GAS BARRIER  
 -COMPACTED FILL

**GARAGE SLAB CONSTRUCTION**  
 -5" THK. CONCRETE SLAB R/W 10M @ 18" O/C E.W. ON COMPACTED FILL MATERIAL (TYP.)

**MAIN FLOOR CONSTRUCTION**  
 -FINISH FLOORING AS SPEC'D  
 -3/8" UNDERLAY (WHERE REQ'D)  
 -3/4" T&G FLOOR SHEATHING (GLUED & SCREWED)  
 -FLOOR JOIST/BEAMS AS PER PLAN (VERIFIED WITH SUPPLIER)  
 -CEILING AS INSTRUCTED BY OWNER

**ROOF TYPES**

**SLOPED ROOF CONSTRUCTION**  
 -ROOFING MATERIAL AS SPEC'D  
 -UNDERLAYMENT, EAWE, VALLEY PROTECTION  
 -7/16" EXT. SHEATHING  
 -ROOF TRUSSES AS PER MANUF.  
 -R-50 LOOSE FILL/BATT INSULATION  
 -6 MIL POLY VAPOUR BARRIER  
 -1/2" CEILING G.W.B.

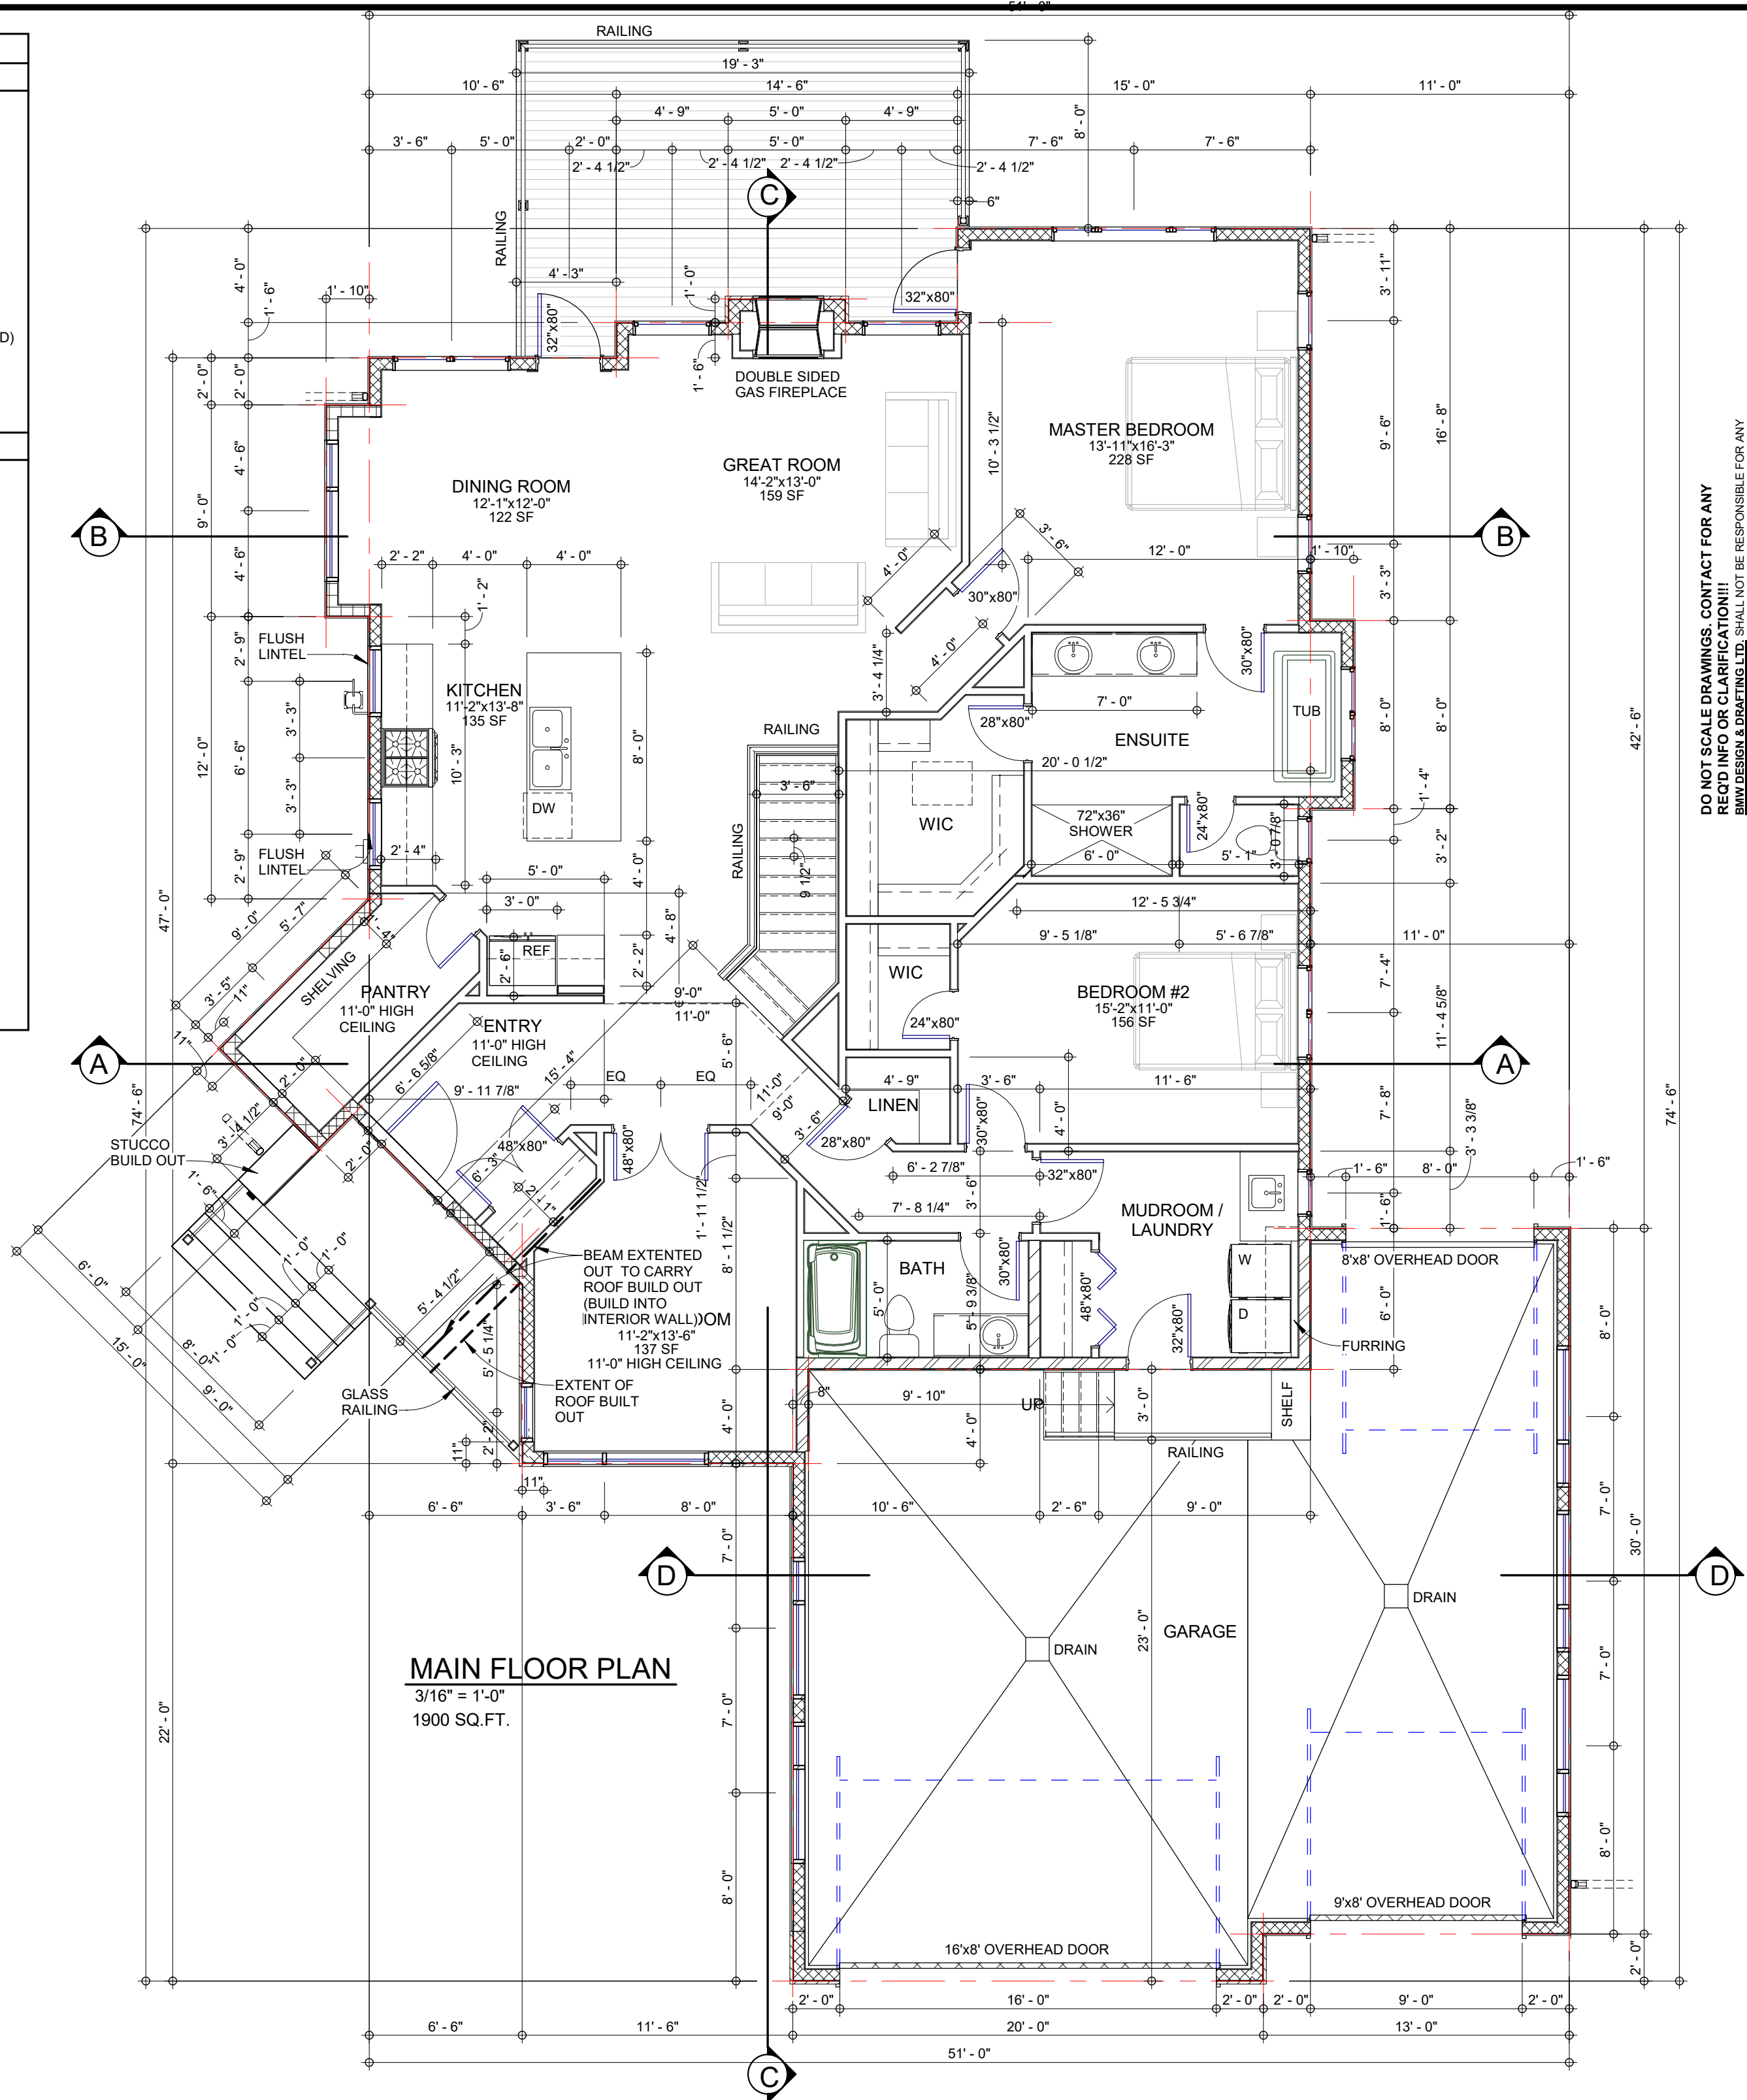

**MAIN FLOOR PLAN**  
 3/16" = 1'-0"  
 1900 SQ.FT.

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 PLANS PLEASE ADVISE OUR OFFICE SO WE CAN MAKE THE NECESSARY CORRECTIONS.

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**B.M.W.**  
 Design & Drafting Ltd.  
 #21-28112 TWP RD 542A  
 BRIMLEY COUNTY, AB

**DAYNEL HOMES**



**GENERAL NOTES**

- ALL SCOPES OF WORK SHALL MEET THE ALBERTA BUILDING CODE (ABC) (LATEST EDITION).
- THE CONTRACTOR/OWNER SHALL BE RESPONSIBLE FOR OBTAINING ALL REQUIRED PERMITS REQUIRED FOR COMPLETING PROJECT.
- OWNER SHALL INSURE QUALITY OF WORK MEETS HIS/HER STANDARDS.
- THE CONTRACTOR/OWNER SHALL BE RESPONSIBLE FOR OBTAINING ANY STRUCTURAL, MECHANICAL, ELECTRICAL DRAWINGS OR APPROVALS NEEDED TO COMPLETE THE PROJECT OR FOR OBTAINING PERMITS.
- THE CONTRACTOR/OWNER SHALL BE RESPONSIBLE FOR OBTAINING SOILS REPORT AS REQUIRED AND INSURING FOOTINGS/FOUNDATIONS AS DRAWN ARE SUFFICIENT
- THE CONTRACTOR/OWNER SHALL INSURE ALL ASPECTS OF THE REQUIRED BYLAWS ARE MET.
- ALL UTILITY HOOKUPS SHALL CONFORM WITH ALL RELEVANT REGULATIONS
- PRIOR TO CONSTRUCTION, ALL CONTRACTORS SHALL FAMILIARIZE THEMSELVES WITH THE DRAWINGS AND INSURE ALL ASPECTS OF THE A.B.C. ARE MET.
- ALL CONTRACTORS SHALL CARRY LIABILITY INSURANCE ACCEPTABLE TO THE OWNER.
- ALL LABOUR LAWS AND SAFETY STANDARDS MUST BE ADHERED TO.
- THE CONTRACTOR/OWNER SHALL HIRE AN ALBERTA LAND SURVEYOR FOR THE PURPOSE OF LOCATING THE PROPOSED BUILDING ON SITE AND ESTABLISHING GRADES.
- THE OWNER SHALL BE RESPONSIBLE FOR THE SELECTION OF ALL INTERIOR DESIGN ELEMENTS (E.G., TUBS, FIXTURES, LIGHTS, ETC.)
- ANY FUEL FIRED APPLIANCE AS CHOSEN BY THE OWNER SHALL BE INSTALLED IN ACCORDANCE WITH THE ALBERTA BUILDING CODE.
- FOOTINGS SHALL REST ON UNDISTURBED SOIL AND HAVE MIN 5'-0" OF FROST PROTECTION.
- JOIST AND TRUSS LAYOUT/SIZES SHALL BE VERIFIED BY SUPPLIER. SHOP DRAWINGS OF JOIST/TRUSSES SHALL BE PROVIDED AND SHALL NOTE ANY EXTRA FOOTING, BEAMS, COLUMNS, JOISTS, ETC. TO INSURE CONSTRUCTION MEETS CODE. ANY CHANGE IN FOOTING SIZE, QUANTITY, AND LOCATION AS REQUIRED BY JOIST SUPPLIER TO BE NOTED BY CONTRACTOR/OWNER. CONTRACTOR/OWNER TO INSURE MODIFICATIONS ARE CARRIED OUT.
- WINDOW SIZES ARE SHOWN ON BUILDING ELEVATIONS AND ARE SHOWN BY NOMINAL SIZE. OWNER TO VERIFY STYLE, TYPE, AND EXACT ROUGH OPENING SIZE PRIOR TO CONSTRUCTION. OWNER TO ALSO VERIFY DIRECTION OF OPENERS
- ALL FRAMING SURROUNDING TUBS, SHOWER, ETC. AS SELECTED BY OWNER SHALL BE VERIFIED TO INSURE FIXTURES ARE INSTALLED CORRECTLY.
- ALL BATHROOM WALLS TO BE INSULATED WITH BATT INSULATION FOR NOISE ATTENUATION. OWNER TO INSTRUCT FOR OTHER INSULATED WALLS.
- PRE-MANUFACTURED TRUSSES MUST BE DESIGNED AND SEALED BY A PROFESSIONAL ENGINEER REGISTERED IN THE PROVINCE OF ALBERTA.
- INCREASE WIDTH OF WALL TO CONCEAL WIDTH OF DROP BEAM IF APPLICABLE. VERIFY WITH BEAM SIZES.
- INSURE NO PLUMBING PIPES ARE PLACED IN EXTERIOR WALLS. VERIFY ON SITE, EXACT LOCATION OF REQUIRED PLUMBING PIPES.
- PROVIDE CLOSER & WEATHERSTRIPPING ON DOOR BETWEEN GARAGE AND LIVING AREA (IF APPLICABLE). ALL WALLS/CEILINGS BETWEEN GARAGE AND LIVING SPACE TO BE CONSTRUCTED TO PROVIDE AN EFFECTIVE BARRIER TO GAS AND EXHAUST FUMES
- PROVIDE REQUIRED SOFFIT PROTECTION, FIRE RATED EXTERIOR WALL, GLAZING LIMITATIONS AS PER THE REQUIREMENTS OF THE HIGH INTENSITY RESIDENTIAL FIRES (HIRF) FIRE CODES
- PROVIDE ROUGH-IN OF SOIL GAS CONTROL AS REQUIRED BY SECTION 9.13.4 OF THE ABC (LATEST EDITION)
- EXTERIOR WALLS WITHIN 1.2m (4'-0") OF THE PROPERTY LINE ARE TO HAVE A MINIMUM FIRE RESISTANCE RATING OF 45 MIN.
- ROOM SIZES AS INDICATED MAY VARY FROM ACTUAL CONSTRUCTED STRUCTURE

**ROOF NOTES**

**BUILDERS SPECIFICATION MAY GOVERN OVER THESE NOTES**

- ROOFING SLOPE AS INDICATED ON PLANS, SECTIONS AND ELEVATIONS
- ROOFING FINISH TO BE ASPHALT SHINGLES
- PROVIDE INSULATED ACCESS HATCH C/W WEATHERSTRIPPING
- PROVIDE ROOF VENTS AS REQUIRED
- PROVIDE PREFINISHED METAL EAVESTROUGH C/W REQ'D MOUNTING HARDWARE AND R.W.L. & EXTENTIONS
- PRE-MANUFACTURED HIGH HEEL ROOF TRUSSES TO BE DESIGNED AND SEALED BY A PROFESSIONAL ENGINEER
- VERIFY LOCATION OF ALL R.W.L ON SITE
- PROVIDE PEEL AND STICK MEMBRANE AT EAVES, VALLEYS AND LOW SLOPE ROOF AREAS

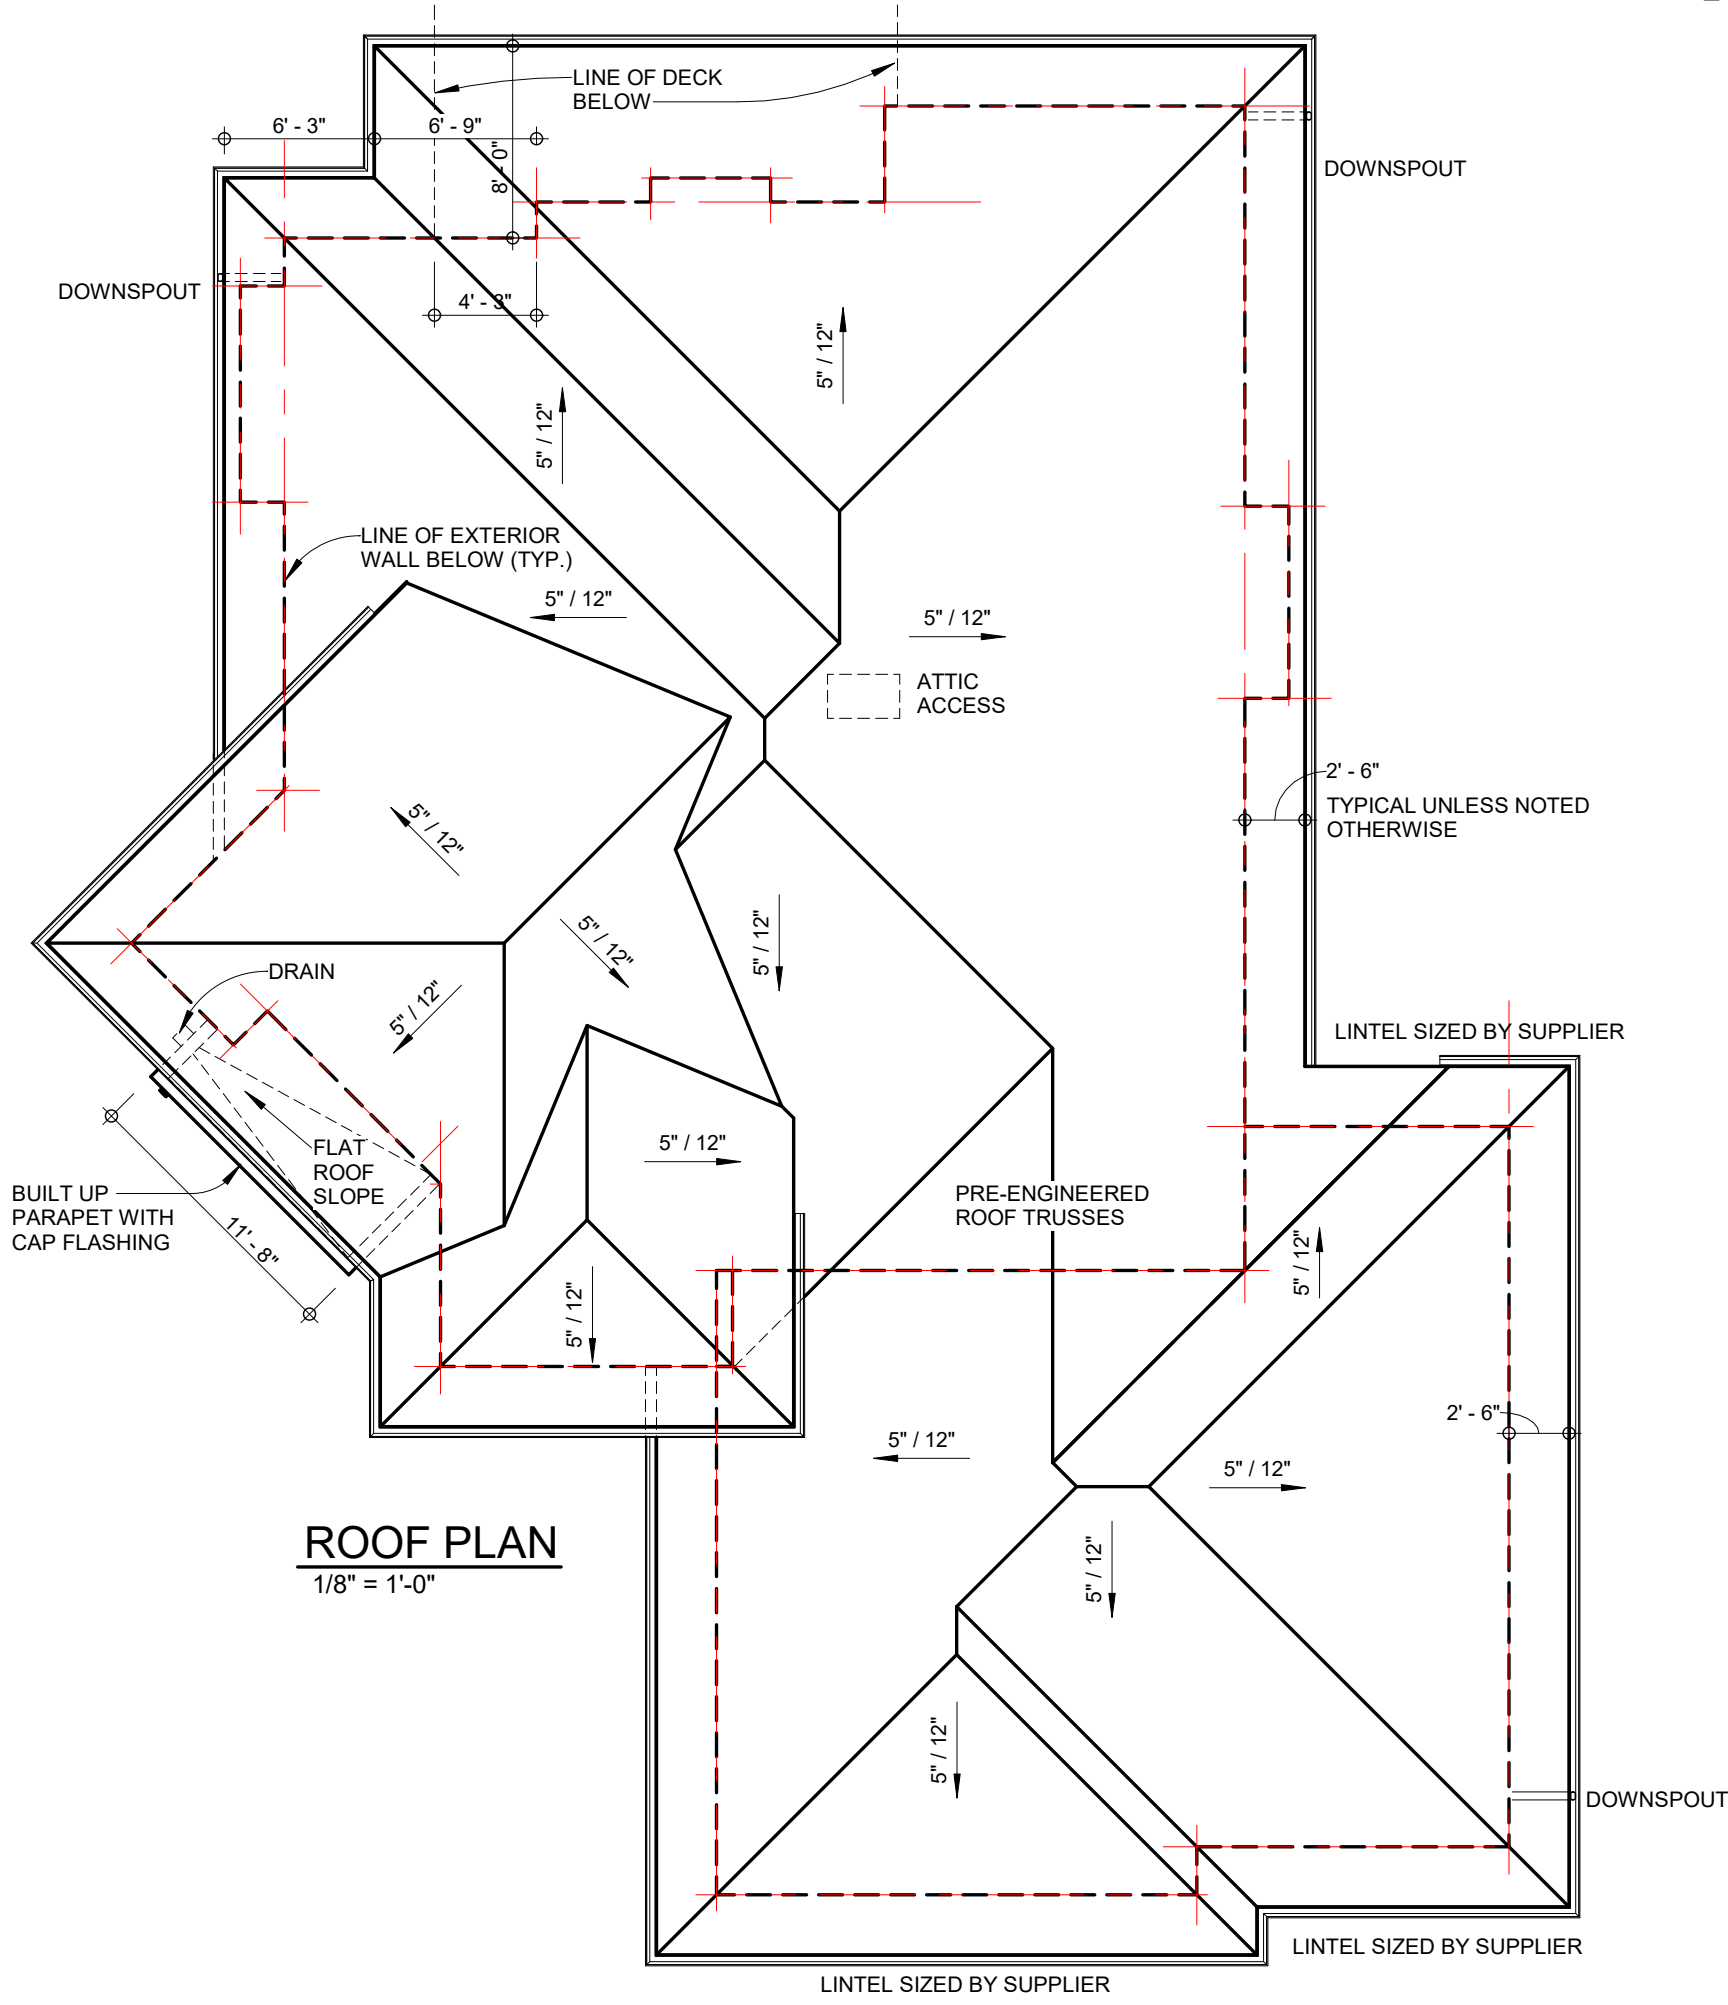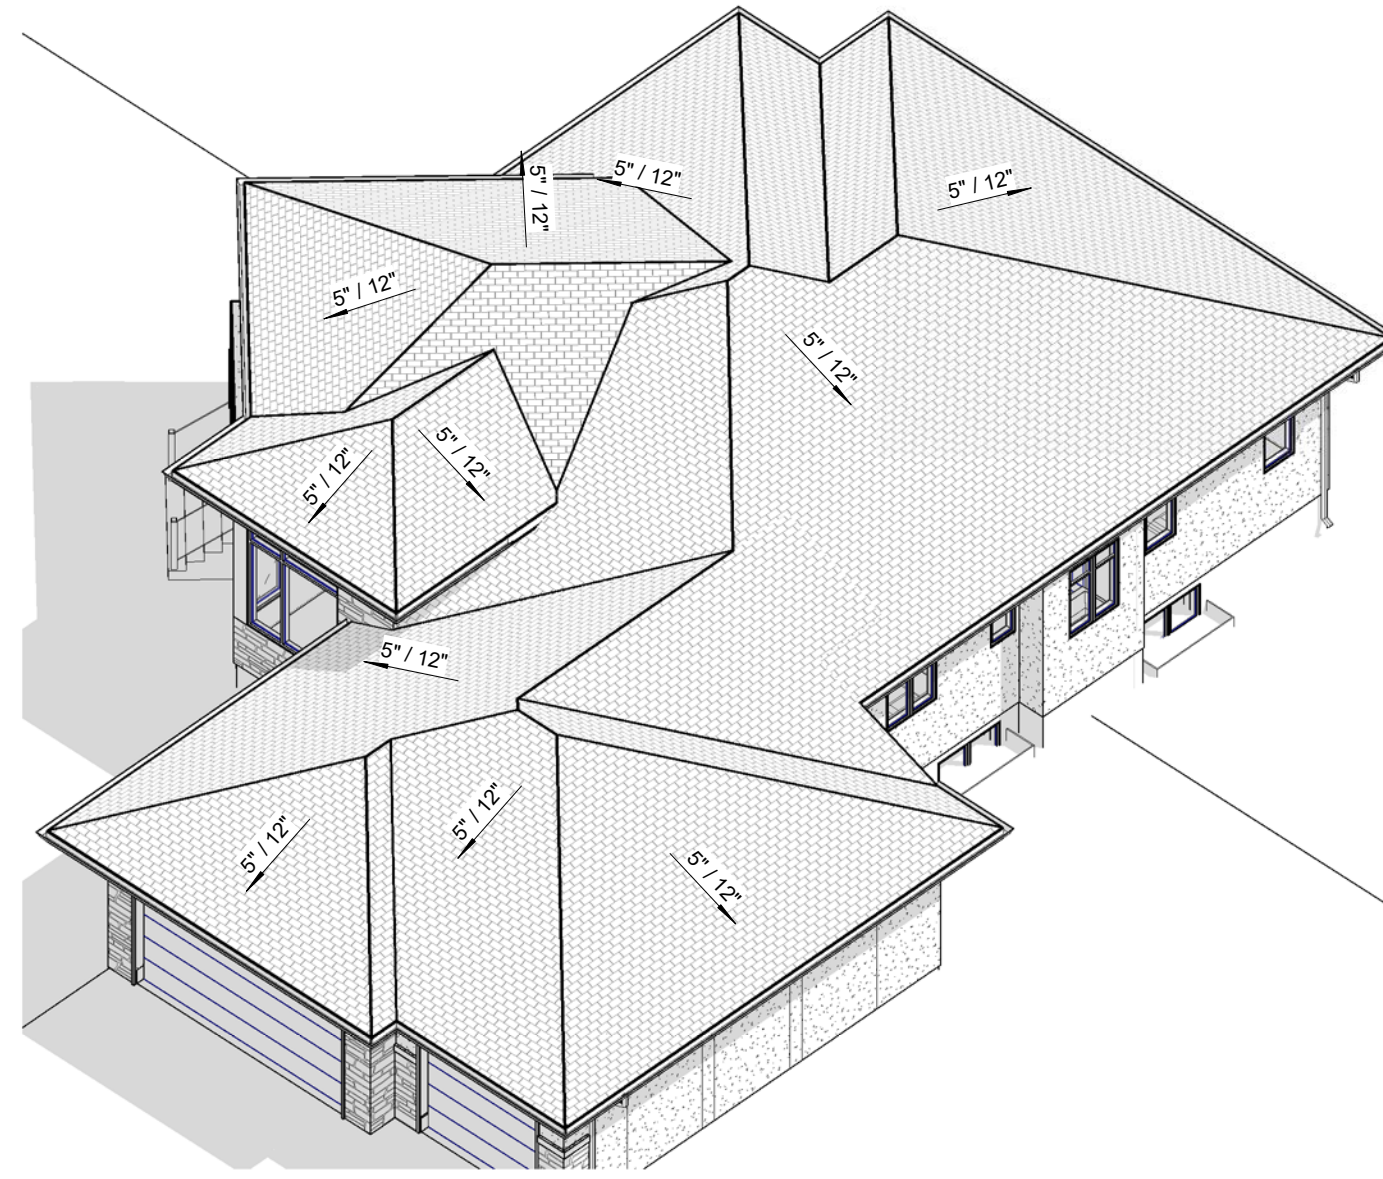

**ROOF PLAN**  
1/8" = 1'-0"


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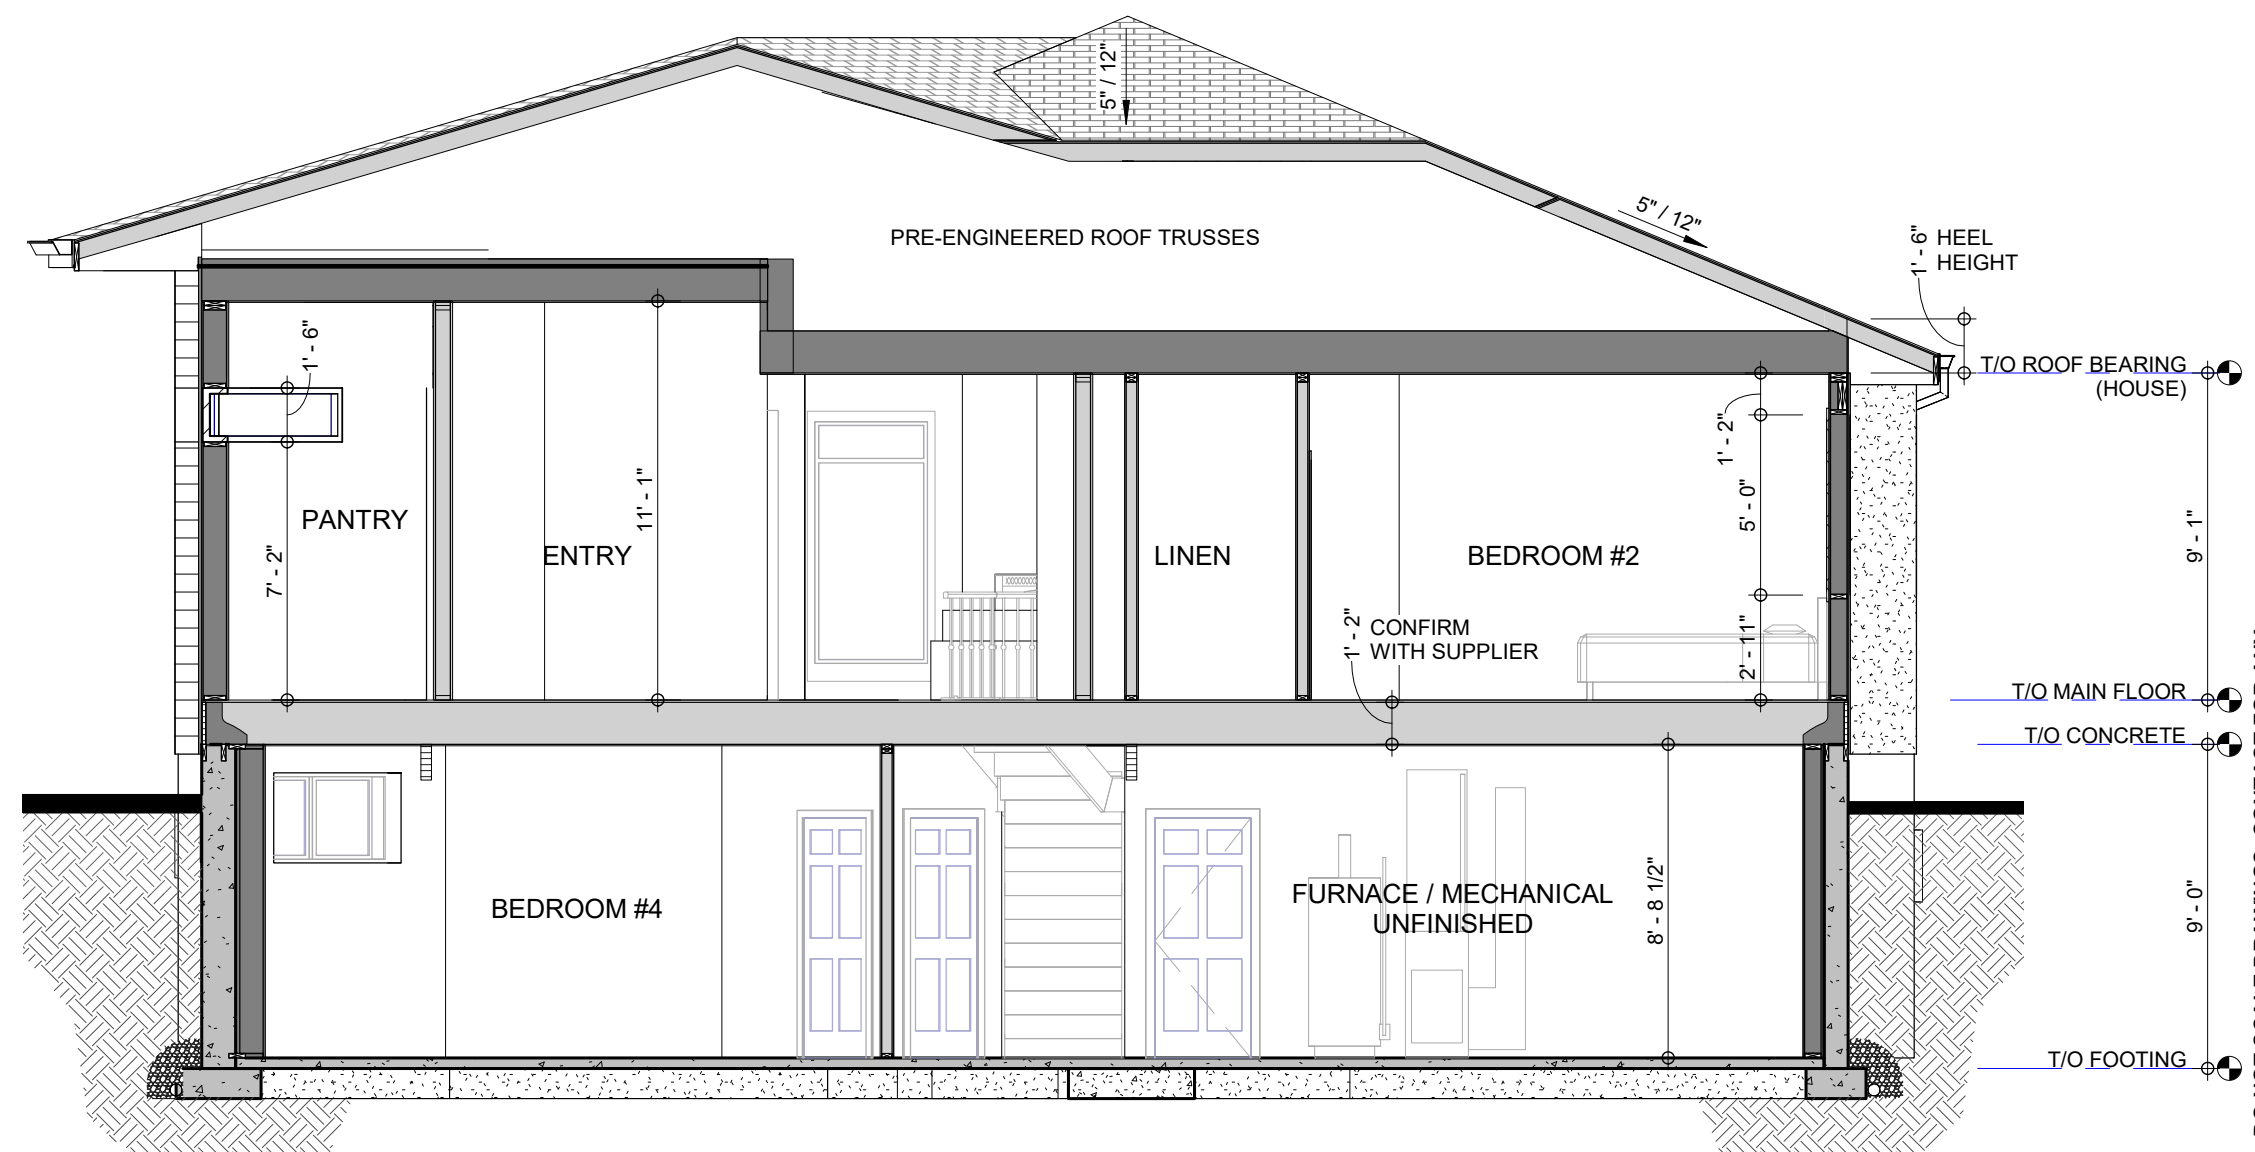
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**DAYNEL HOMES**


**A-4**




**B** BUILDING SECTION B  
3/16" = 1'-0"

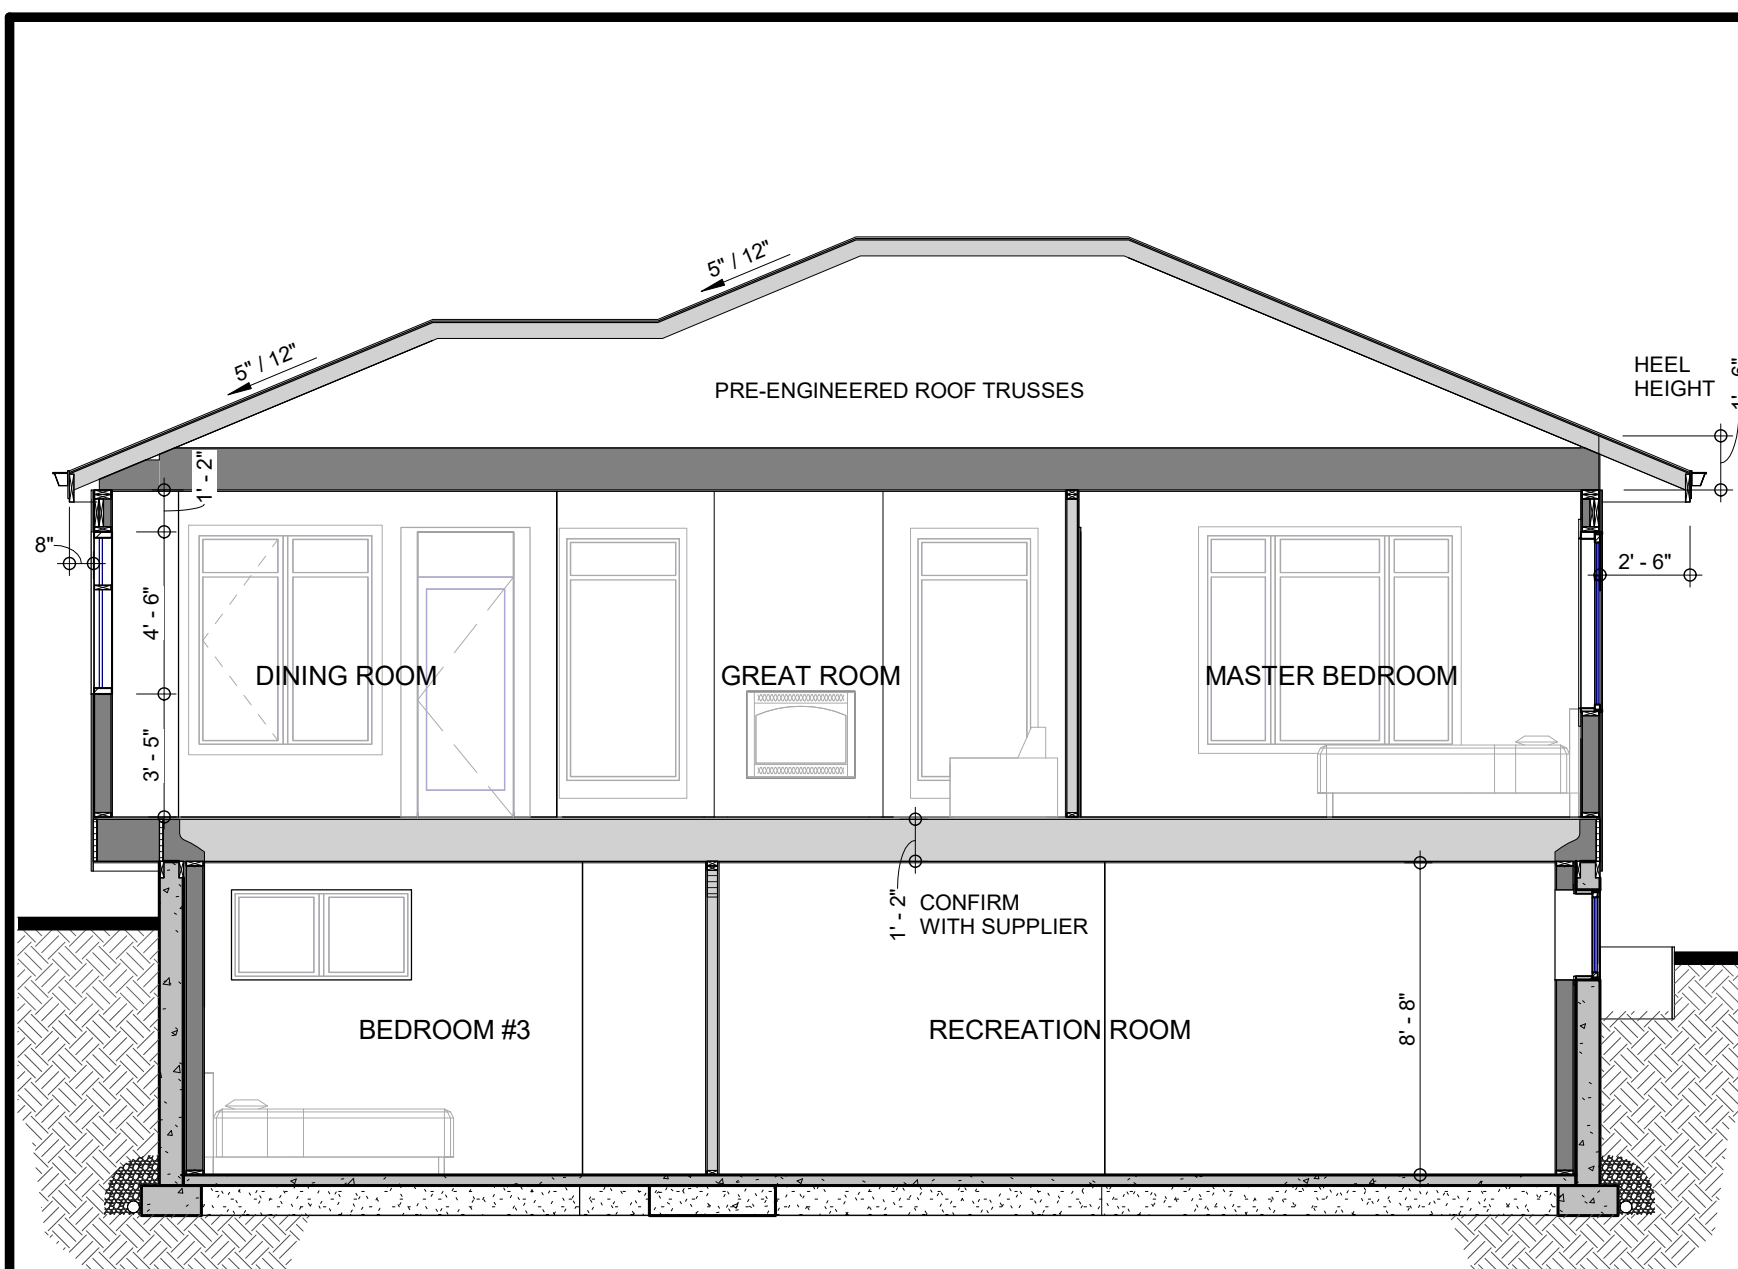

**A** BUILDING SECTION A  
3/16" = 1'-0"

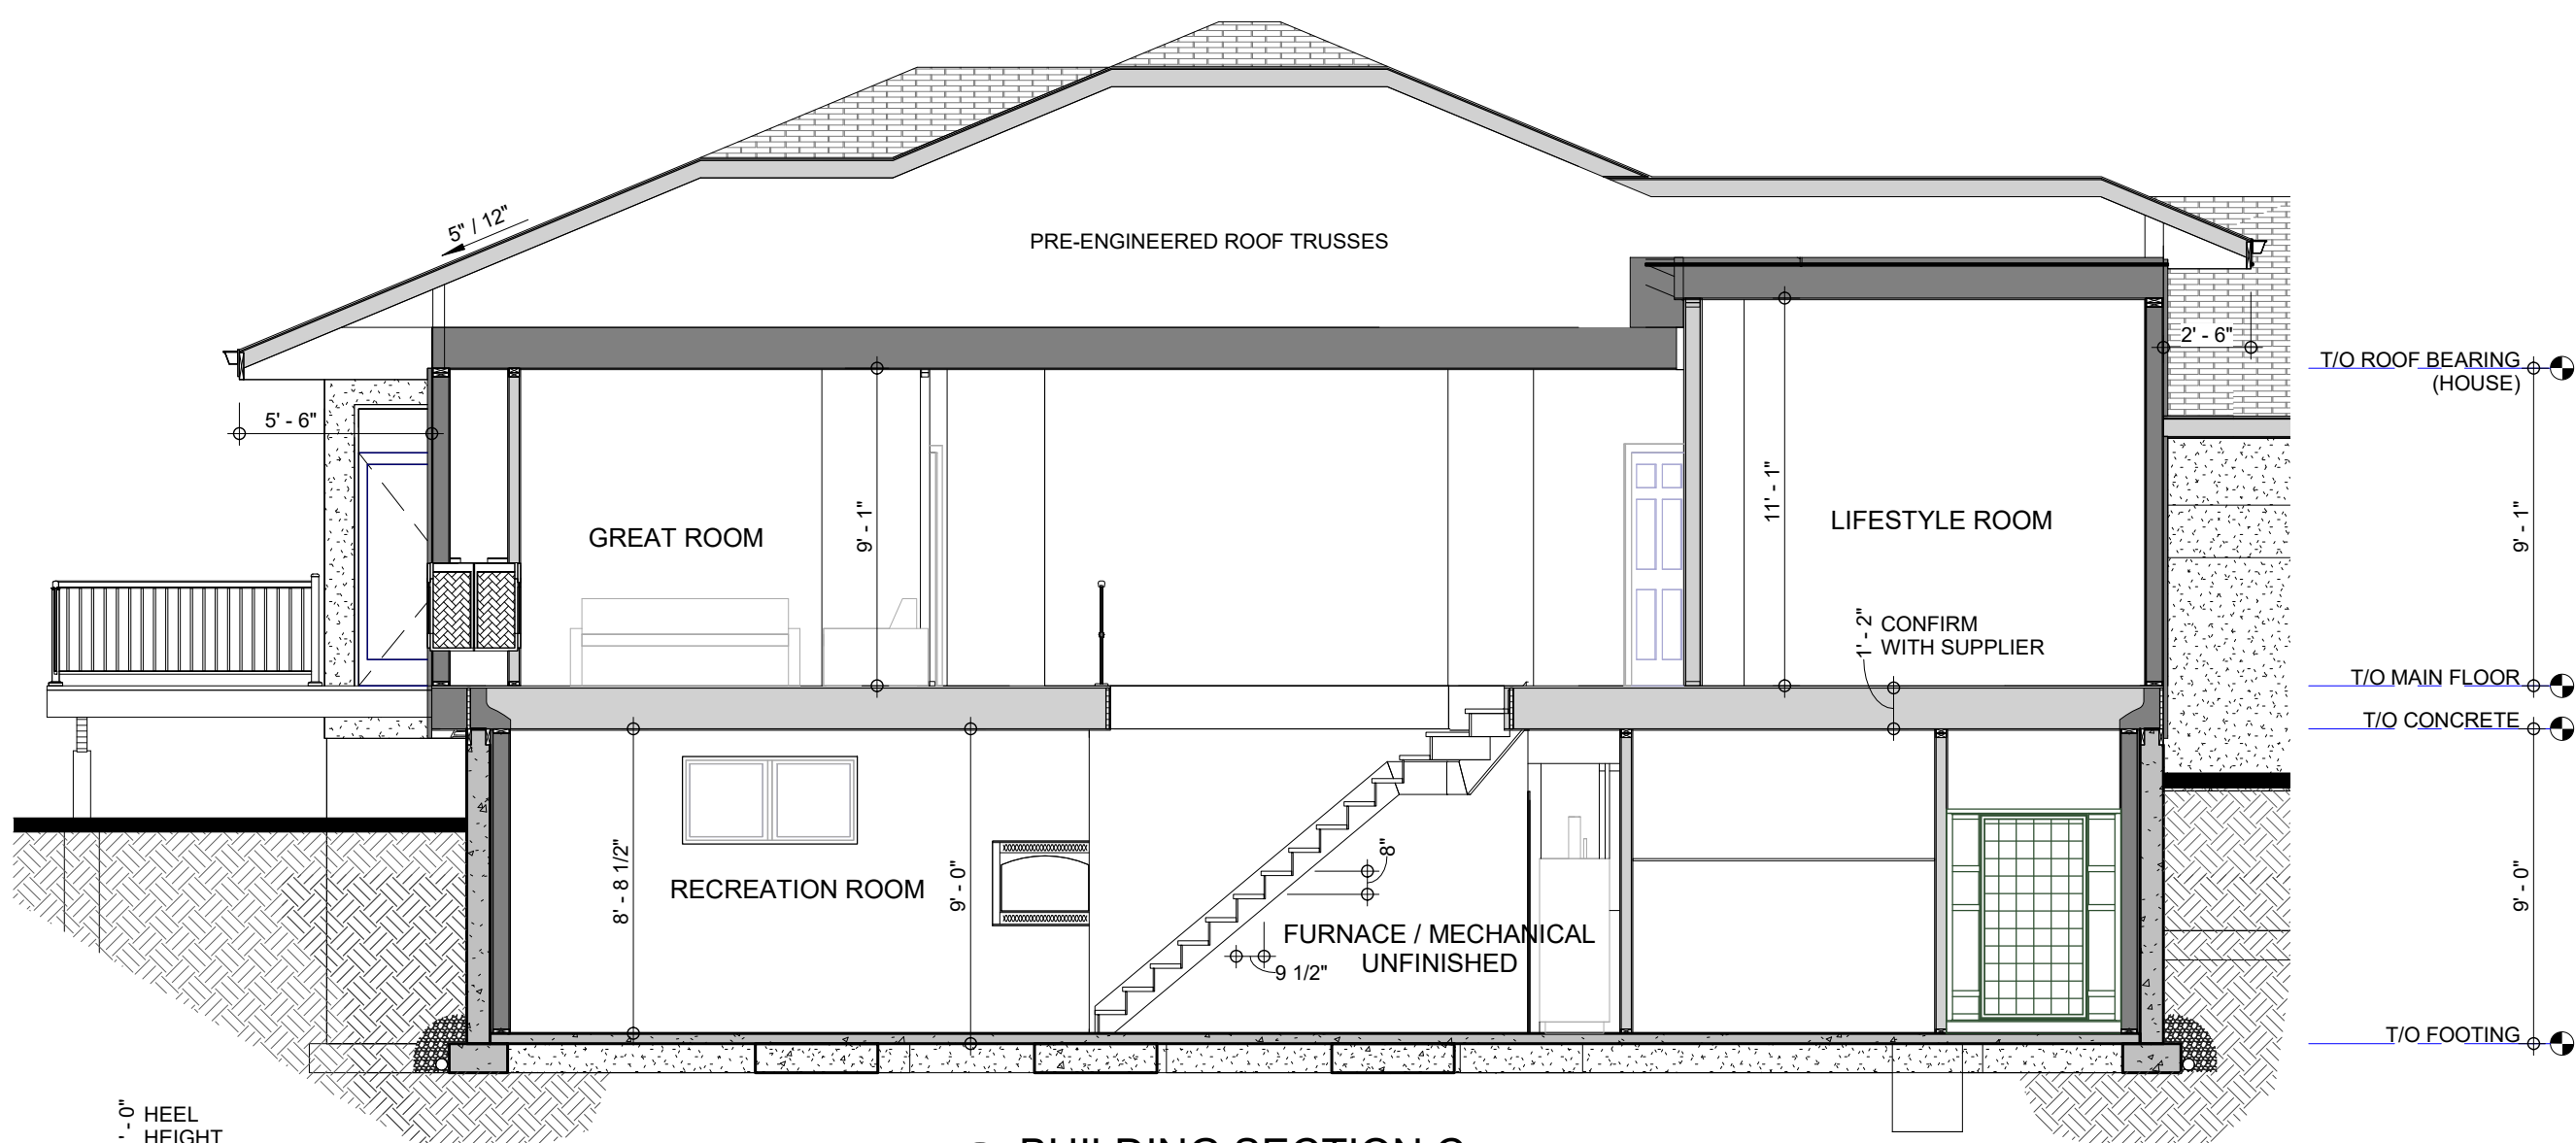

**C** BUILDING SECTION C  
3/16" = 1'-0"

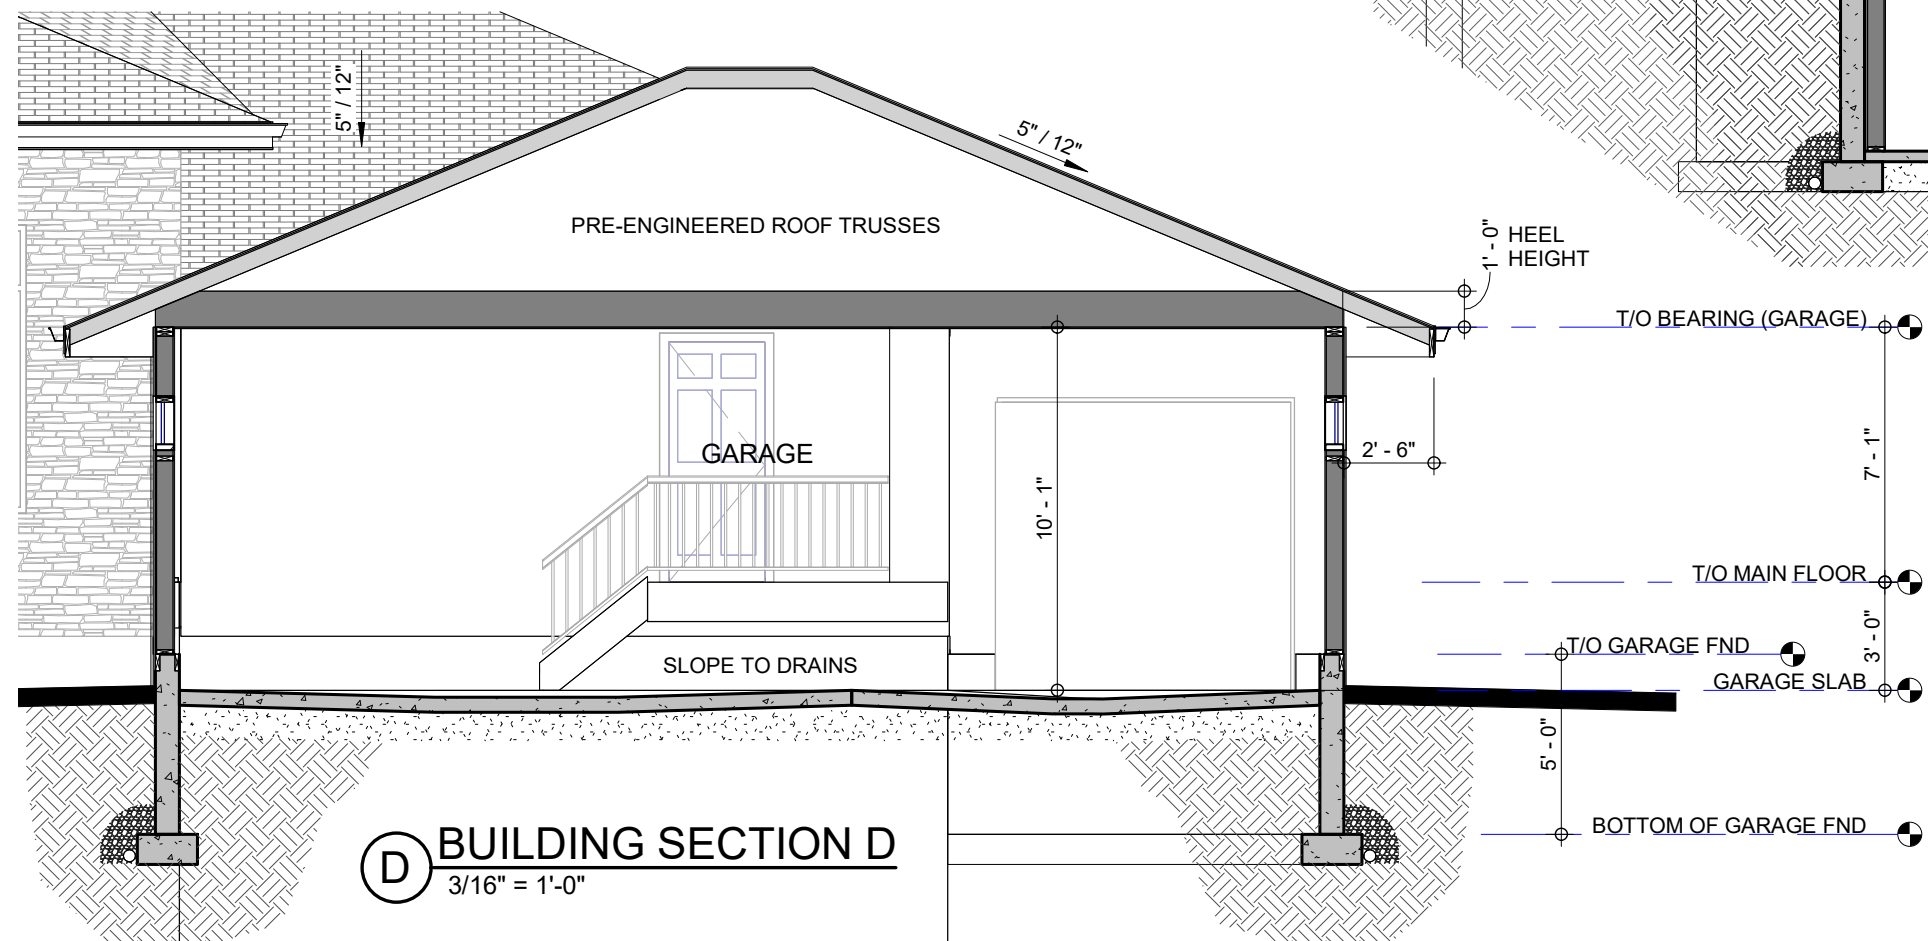


**D** BUILDING SECTION D  
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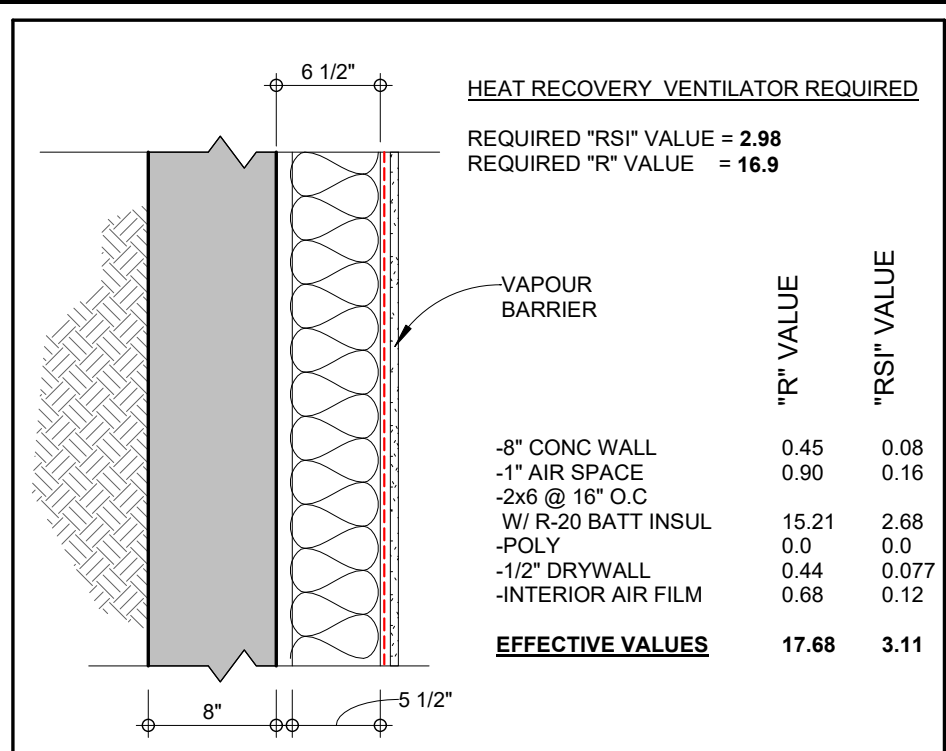
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**B·M·W**  
 Design & Drafting Ltd.  
 #21-28110 TWP RD 542A  
 331 DEL  
**DAYNEL HOMES**



TYPICAL ATTIC ACCESS HATCH



FW1 - FOUNDATION WALLS

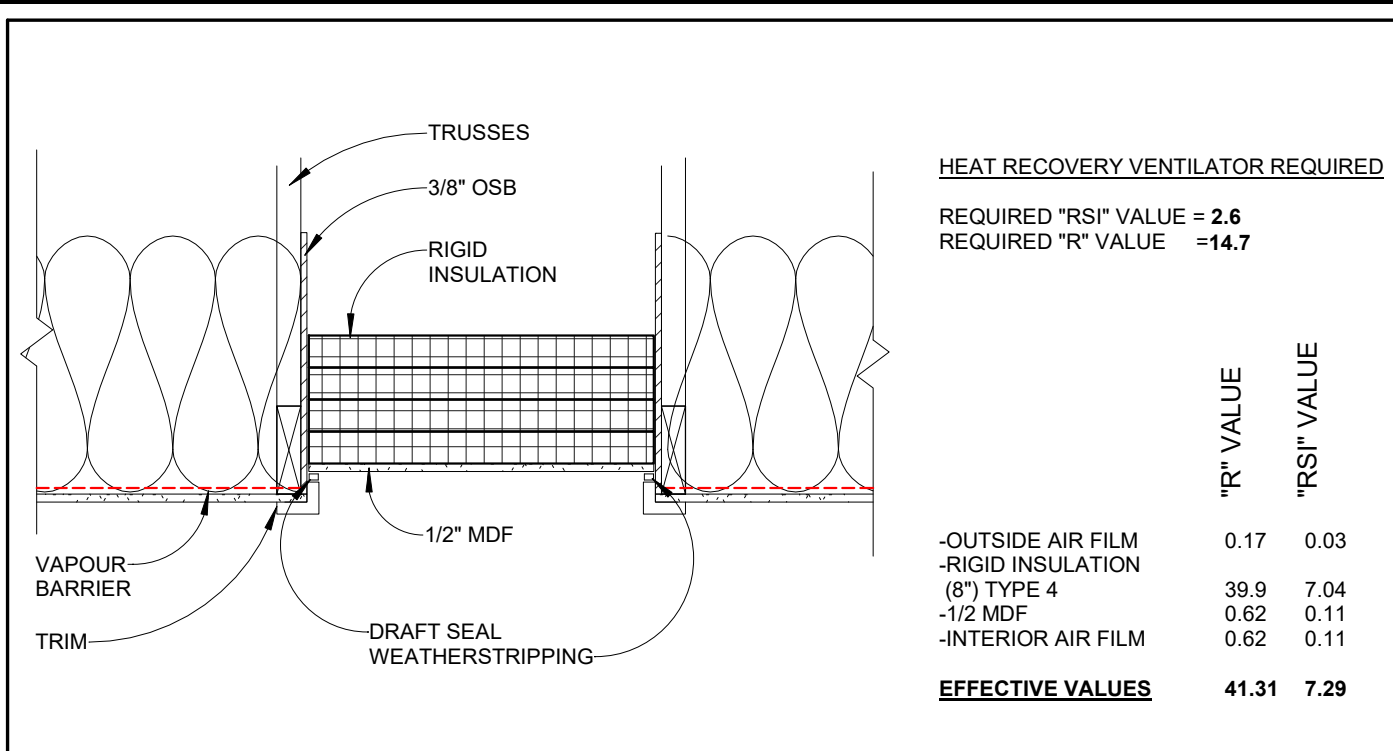**ENERGY EFFICIENCY REQUIREMENTS (ZONE 7A)**  
**FENESTRATION AND DOOR COMPONENTS**  
 -AS PER 9.36.2.7.A (ABC) MAXIMUM "U" VALUE FOR WINDOWS TO BE 1.60  
 -AS PER 9.36.2.7.A (ABC) MAXIMUM "U" VALUE FOR EXTERIOR DOORS TO BE 1.60  
 -AS PER 9.36.2.7.(5) (ABC) MAXIMUM "U" VALUE FOR ONE SINGLE EXTERIOR DOOR EXCEPTION TO BE 2.60  
 -AS PER 9.36.2.7.(4) (ABC) MAXIMUM "U" VALUE FOR GLASS BLOCK (1.85M<sup>2</sup>) TO BE 2.90  
 -AS PER 9.36.2.7.(4) (ABC) MAXIMUM "U" VALUE FOR SKYLIGHTS WINDOWS TO BE 2.70  
 -AS PER 9.36.2.7.(7) (ABC) MINIMUM RSI FOR GARAGE OVERHEAD DOORS TO BE 1.1  
 -AS PER 9.36.2.7.(8) (ABC) MINIMUM RSI FOR ATTIC HATCH TO BE 2.6

-ALL MECHANICAL EQUIPMENT AND INSTALLATION TO MEET THE REQUIREMENTS IN SECTION 9.36  
 -ALL ELECTRICAL EQUIPMENT/FITMENST AND INSTALLATION TO MEET THE REQUIREMENTS IN SECTION 9.36

**DETAILS SHOWN AND "ETR" LISTED ARE FOR STRUCTURES WHERE HEAT RECOVERY VENTILATOR IS PROVIDED.**

MINIMUM "ETR" EFFECTIVE THERMAL RESISTANCE FOR LISTED COMPONENTS WITH THE USE OF A HEAT RECOVERY VENTILATOR	MINIMUM "ETR" EFFECTIVE THERMAL RESISTANCE FOR LISTED COMPONENTS WITHOUT THE USE OF A HEAT RECOVERY VENTILATOR	
<b>ABOVE GROUND ASSEMBLIES</b>	<b>ABOVE GROUND ASSEMBLIES</b>	
CEILING BELOW ATTICS	CEILING BELOW ATTICS	
CATHEDRAL CEILING OR FLAT ROOF	CATHEDRAL CEILING OR FLAT ROOF	
WALL AND FOUNDATION EXPOSURE AVERAGE > 600mm	WALL AND FOUNDATION EXPOSURE AVERAGE > 600mm	
FLOOR OVER UNHEATED SPACES	FLOOR OVER UNHEATED SPACES	
TALL WALL	TALL WALL	
<b>EFFECTIVE VALUES</b>	<b>EFFECTIVE VALUES</b>	
CEILING BELOW ATTICS	=8.67	=10.43
CATHEDRAL CEILING OR FLAT ROOF	=5.02	=5.02
WALL AND FOUNDATION EXPOSURE AVERAGE > 600mm	=2.97	=3.08
FLOOR OVER UNHEATED SPACES	=5.02	=5.02
TALL WALL	=2.97	=3.08
<b>BELOW GRADE OR GROUND CONTACT ASSEMBLIES</b>	<b>BELOW GRADE OR GROUND CONTACT ASSEMBLIES</b>	
WALLS AND FOUNDATION EXPOSURE AVERAGE UP TO 600mm	WALLS AND FOUNDATION EXPOSURE AVERAGE UP TO 600mm	
UNHEATED FLOOR - BELOW FROST LINE	UNHEATED FLOOR - BELOW FROST LINE	
UNHEATED FLOOR - ABOVE FROST LINE	UNHEATED FLOOR - ABOVE FROST LINE	
HEATED FLOOR	HEATED FLOOR	
SLAB ON GROUND WITH INTERGAL FOOTING	SLAB ON GROUND WITH INTERGAL FOOTING	
<b>EFFECTIVE VALUES</b>	<b>EFFECTIVE VALUES</b>	
WALLS AND FOUNDATION EXPOSURE AVERAGE UP TO 600mm	=2.98	=3.46
UNHEATED FLOOR - BELOW FROST LINE	=0	=0
UNHEATED FLOOR - ABOVE FROST LINE	=1.96	=1.96
HEATED FLOOR	=2.84	=2.84
SLAB ON GROUND WITH INTERGAL FOOTING	=2.84	=2.84

**DO NOT SCALE DRAWINGS. CONTACT FOR ANY RED INFO OR CLARIFICATION!!!**  
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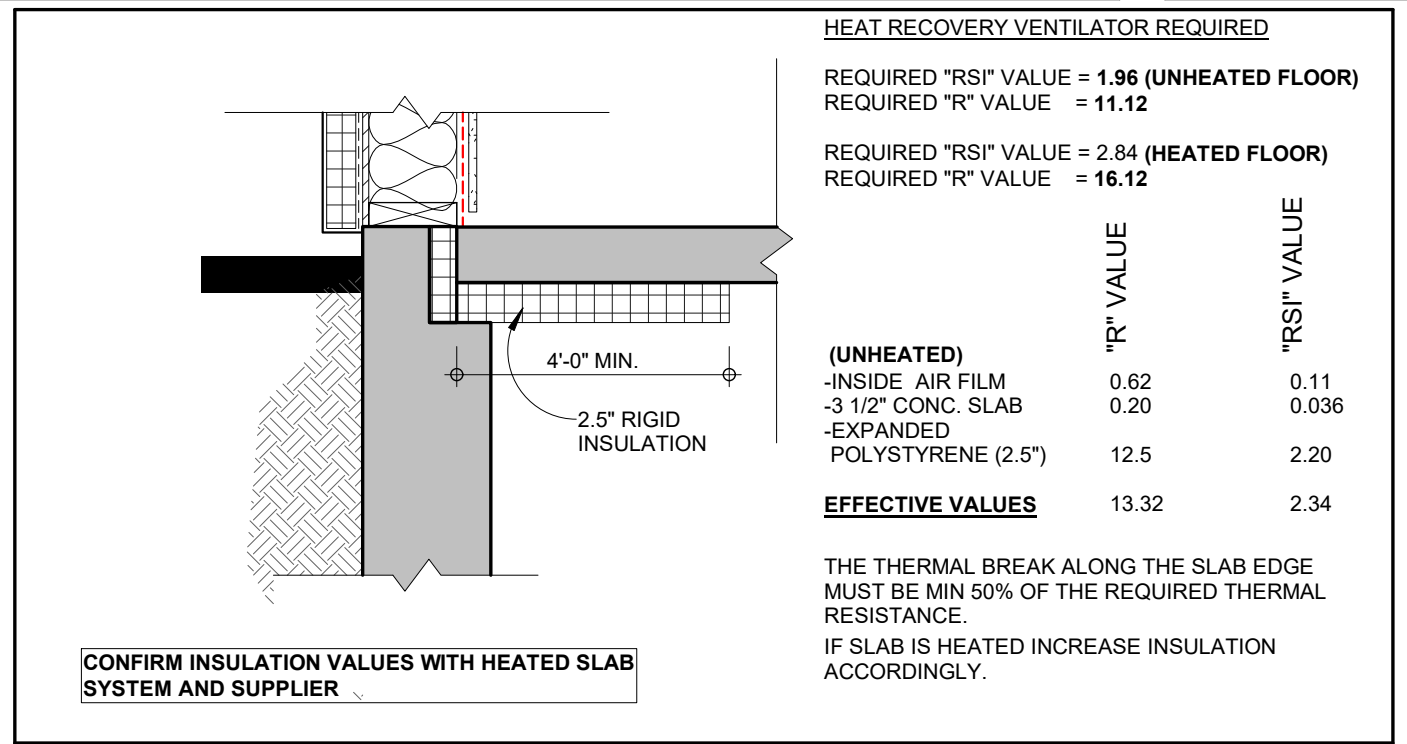
Project No: 2019-61  
 Date: JULY 2019  
 Scale: 1" = 1'-0"  
 Drawn By: BMW  
 Builder File: LACOMBE PARK  
 Address:

Legal Description:  
 Lot: 132  
 Block: 10  
 Plan: 142 4849  
 Subdivision: LACOMBE PARK


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**B·M·W**  
 Design & Drafting Ltd.  
 #21-28112 TWP RD 542A  
 531 URBEL  
 ENERGY DETAILS


**DAYNEL HOMES**  
 A-6




TYPICAL UNHEATED FLOOR INSULATION DETAIL

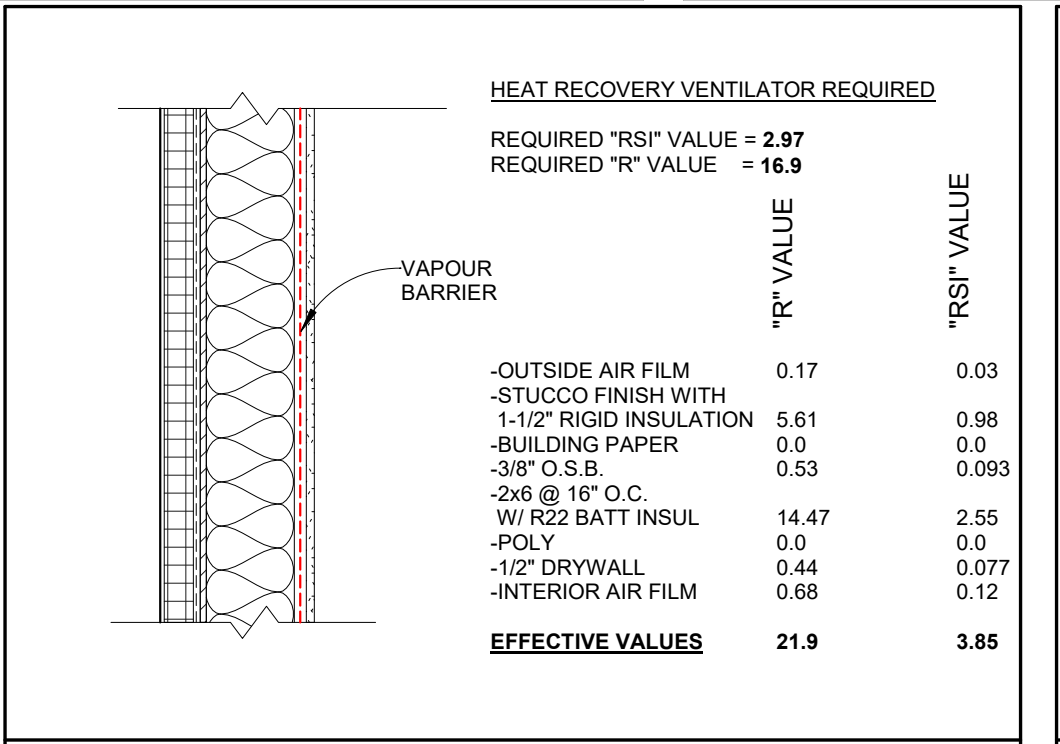


EW1-EXTERIOR WALL - HOUSE/GARAGE

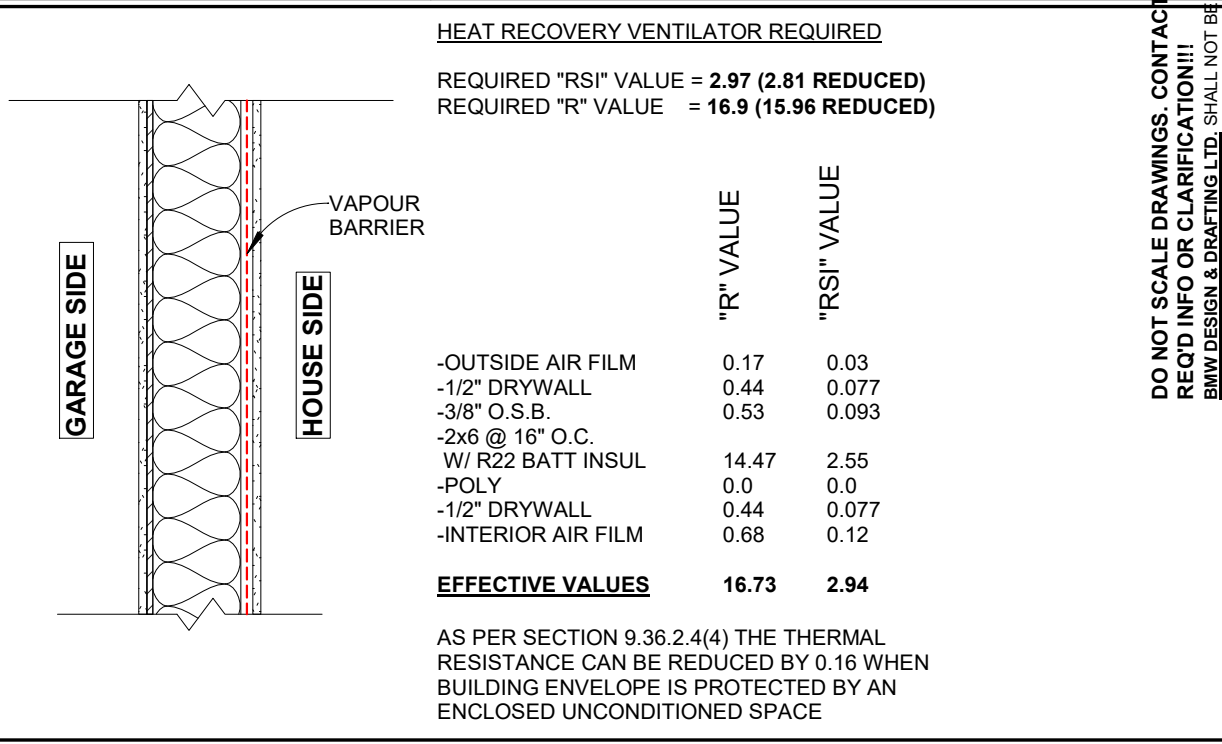


EW2-INTERIOR WALL BETWEEN HOUSE&GARAGE

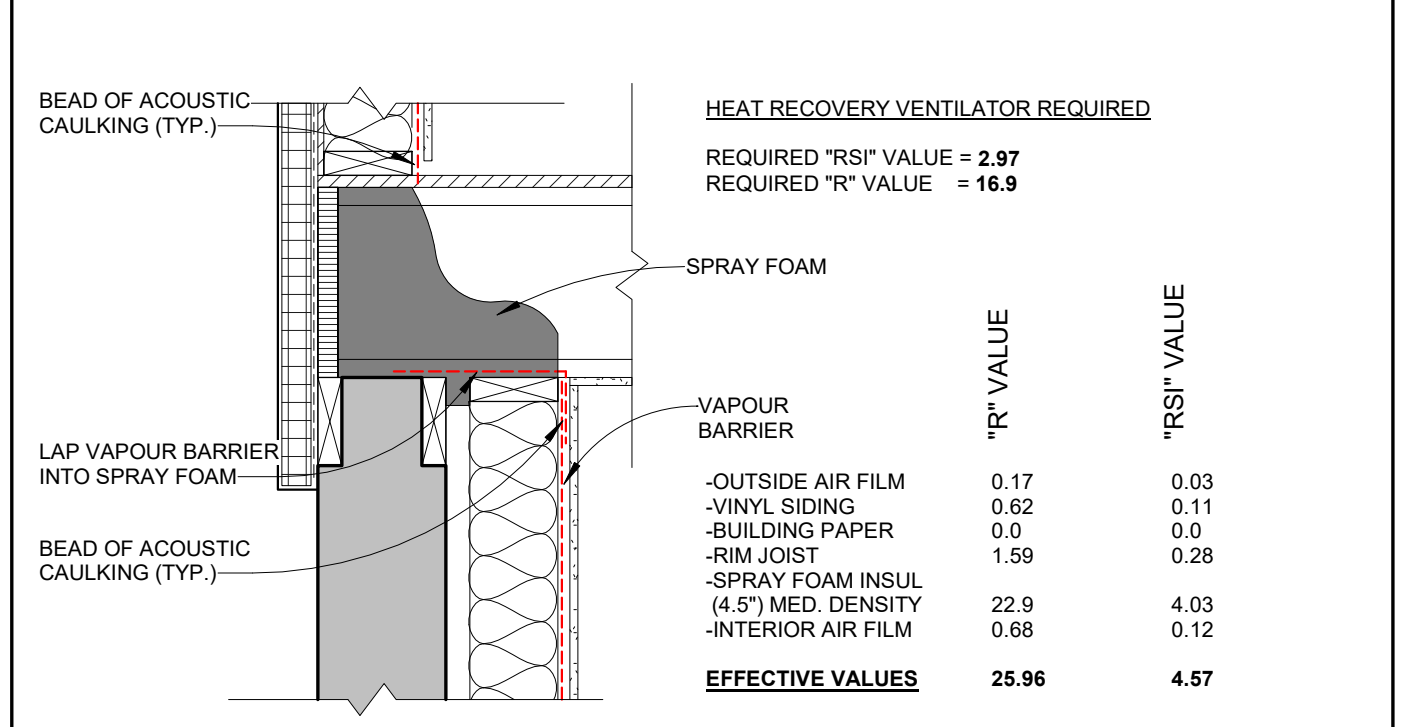

TYPICAL MAIN FLOOR RIM JOIST

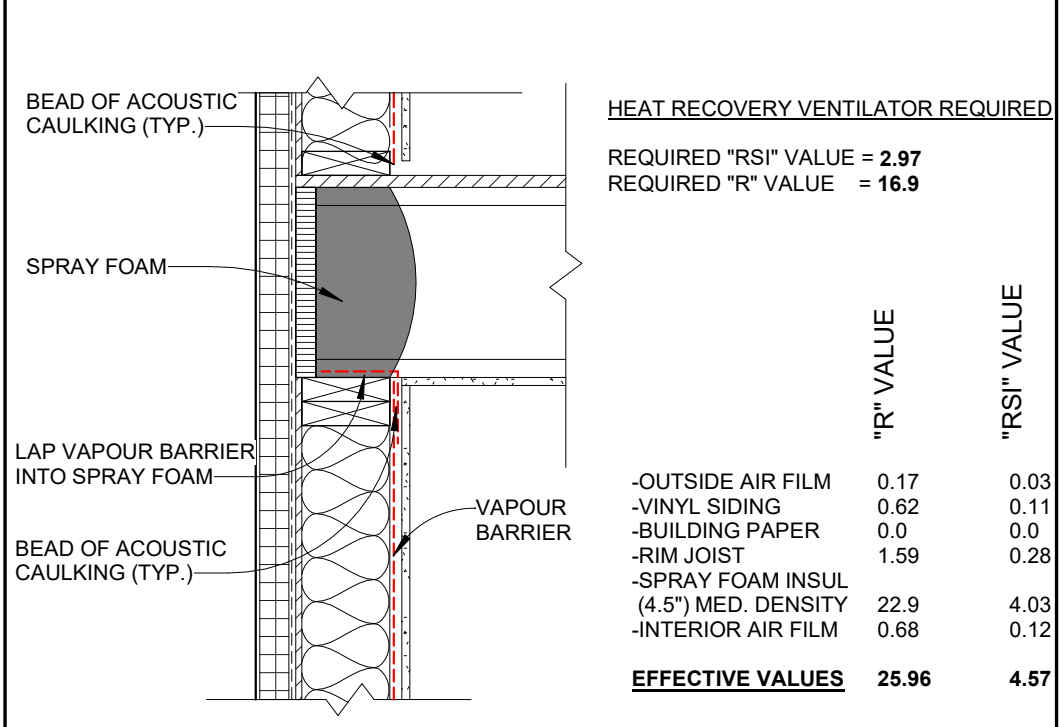


TYPICAL 2ND FLOOR RIM JOIST

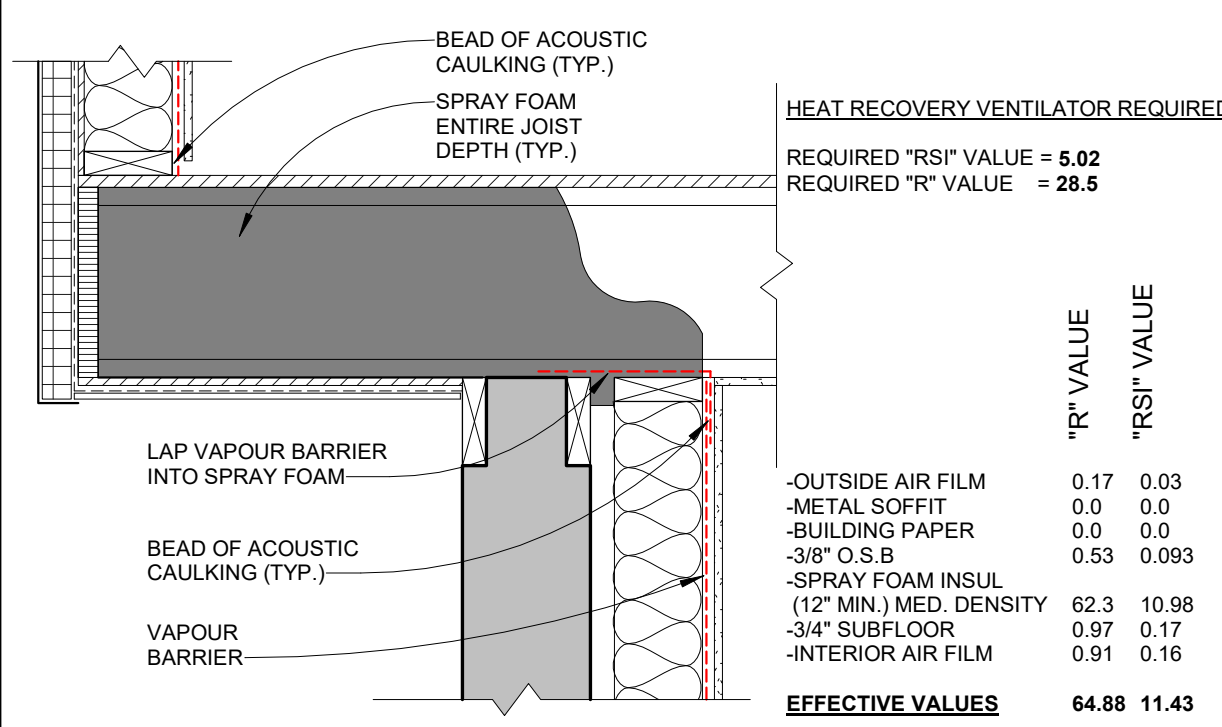

TYPICAL FLOOR CANTILEVER

FLOOR UNDER SUNROOM TO BE SRPAY FOAM AS PER CANTILVER DETAIL

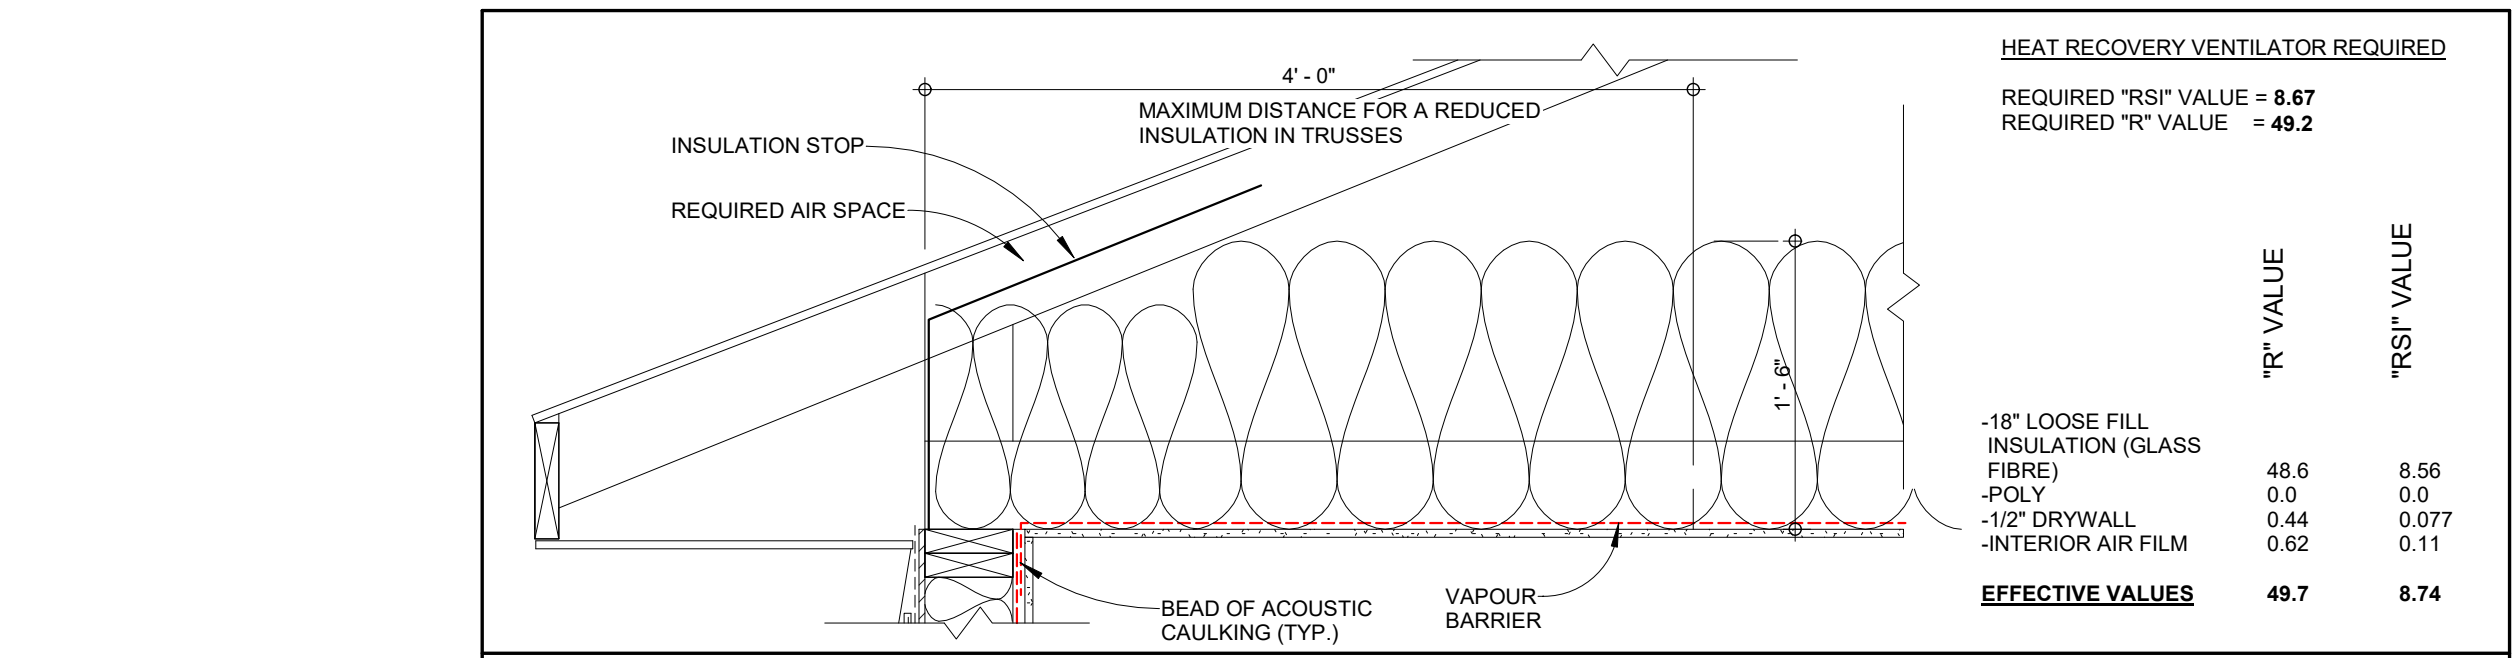

TYPICAL OVERHANG DETAIL